

4 November 2021
Ref. E23243.E99.1_Rev2

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Mr Anas Rahhal
Croatia 88 Pty Ltd
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Re: Review of Environmental Reports for Lot 3 DP1259121 & Part Lot 8, DP1200987, Edmondson Park NSW

1. Introduction

At the request of Mr Anas Rahhal of Croatia 88 Pty Ltd (C-88), EI Australia (EI) was engaged to undertake a Review of Environmental Reports related to land within Lot 3 in Deposited Plan (DP) 1259121 & Part Lot 8 DP1200987, Edmondson Park ("the site"). Located approximately 7km south west of the Liverpool Central Business District (CBD), the site was situated within the Edmondson Park urban release area, earmarked for future residential development by the NSW Government. The subject site was part of a large, irregular shaped block of land situated at the north-western corner Croatia and Somme Ave (see **Figure 1, Attachment A**).

Formerly known as 190 Croatia Avenue, the land block spans approx. 2 ha of land within the local government area of Liverpool City Council, formerly defined as Lot 29 in DP 228850. Residential development of this property was approved by the Sydney Western City Planning Panel (SWCPP) 26 Nov 2019 (DA-265/2018) and included the demolition of existing structures, subdivision and the construction of Stage 1, within the north eastern corner of the land block. Independently of the site works, Croatia Avenue was modified, and the larger lot (Lot 29 in DP 228850) was subdivided. Following the commencement of Stage 1 construction, the client now wishes to seek approval for Stage 2 of the development, within the remaining parts of the former property known as 190 Croatia Avenue.

Site characterisation works were completed by EI for the former site, in support of the consent application for DA-265/2018. The characterisation works included land to be developed as Stage 1 and most of the Stage 2 site, combined. This document provides a review of these investigations, to conclude on the suitability of land within Stage 2 only, being Lot 3 DP1259121 and part of Lot 8 DP1200987, for submission to Liverpool City Council as part of the development application for the Stage 2 works. This review was completed to assist the client in meeting their obligations as required by *State Environmental Planning Policy No.55* (SEPP 55) and the *Contaminated Land Management Act 1997* (the CLM Act).


1.1 Documents Provided

The following documents were included as part of this review:

- EI (2017) Preliminary Site Investigation, 190 Croatia Avenue, Edmondson Park, NSW, Ref: E23243 AA_Rev1, dated 30 November 2017;
- EI (2018) Detailed Site Investigation, 190 Croatia Avenue, Edmondson Park, NSW, Ref: E23243.E02_Rev0, dated 6 February 2018; and
- EI (2020) Preliminary Site Investigation with Limited Sampling, Part of 190 Croatia Avenue, Edmondson Park, NSW, Ref: E23243.E01_Rev0, dated 1 September 2020.

1.2 Proposed Development

EI received a copy of the proposed development plans as presented in **Attachment B** (ref: Stansic Architects (SA), Project No. 20 117 issue A, dated 05 May 2021). The Stage 2 works will be managed across two developable areas of the site, referred to as the 'north' and the 'south' sites as shown in Drawing 1 below. Proposed for Stage 2 South was a single, multi-level apartment building overlying two levels of basement parking, and deep soil landscaping. Stage 2 North involves the construction of two, multi-level apartment buildings overlying a single basement car park, with deep soil landscaping also.

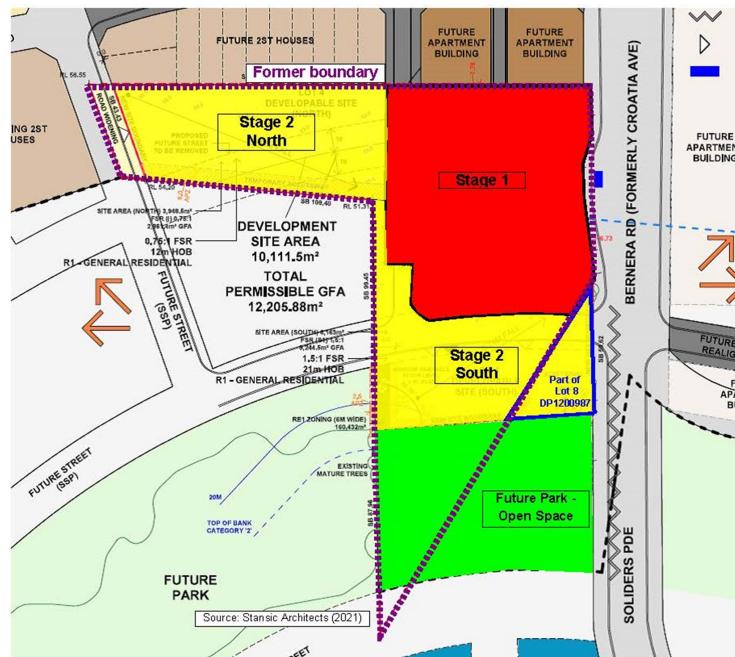

Drawing 1 – Proposed Layout of 361-363 Bernera Rd

2. EI (2017) Preliminary Site Investigation

EI (2017) completed a preliminary site investigation (PSI) for 190 Croatia Avenue, Edmondson Park.. The investigation area covered 2.023 ha and the works were completed to accompany a development application (DA) for the demolition, subdivision and construction of a residential development within the larger land block.

The objective of the PSI was to evaluate the potential for site contamination, as a result of current and historical land use activities occurring within the land block and its surroundings. This was achieved by completing the following scope of works:

- The completion of a desktop study, including the review of:
 - Relevant topographical, geological, hydrogeological, soil landscape and Acid Sulfate Soil maps;
 - Historical aerial photographs and NSW Land and Property information to determine the historical activities likely to have occurred on the land;
 - A review of Liverpool City Council records pertaining to the site, to determine the site's operational history;
 - A search of NSW EPA contaminated land records to identify any significantly contaminated land within, or with the potential to impact the subject site;
- A detailed site walkover inspection and provision of the PSI report.

Pertinent findings of EI (2017) are provided below:

- The site appeared to be a vacant, cleared land block until sometime between 1965 and 1986, when it was developed for rural residential purposes. Historical land use activities were generally residential, and the site setting observed in the 1986 aerial appeared similar to that existing in 2017, prior to demolition.
- Anecdotal information for the Edmondson Park locality indicates significant market gardening activities to have occurred within the area. Given the clearance of the site, EI considered it possible that the land had been used for market gardening related activities, in particular, the southern and western parts of the property.
- Searches of public records did not identify significant storage or use of chemicals within the property, and no notifications of significant contamination were found for the current or surrounding land blocks.
- Sources of potential contamination relevant for the Stage 2 site were identified as:
 - Contamination potentially associated with the importation of fill material, from an of unknown origin and unknown quality;
 - Pesticide use and storage associated with the potential market gardening operations within the western and southern parts of the land block;
 - The weathering of metallic structures surrounding the small metallic sheds in the northern central part of the land block (i.e. along the eastern boundary of the north western part of Stage 2); and
 - Spills and leaks of oils within the sheds noted above.

Waste stockpiles were observed within Stage 1, but were not present within the subject site. EI (2016) identified a potential for contamination within the Stage 2 site which could pose an unacceptable risk to users of a residential land use scenario. A detailed site investigation (DSI) was recommended, to characterise soil and groundwater and ascertain the presence of contamination for the land block.

3. EI (2018) Detailed Site Investigation

EI (2018) completed a DSI for the site known as 190 Croatia Avenue, Edmondson Park, which followed on from the EI (2016) PSI. EI reviewed the proposed works for Stage 1 and found the development to involve a high density residential land use scenario, with ecological considerations applied to areas where deep soil was planned to be retained. Although no development plans were available for the remaining parts of the land block, EI (2018) assumed the remainder of the site would be developed in a similar manner. The site was therefore assessed against criteria applicable to a *residential land use with minimal access to soils (B)* and *recreational, public open space (C)* land use scenario's, as defined by the *National Environmental Protection (Assessment of Site Contamination) Measure 1999 – Amendment 2013* (NEPC, 2013).

The objective of the DSI was to investigate the degree of any potential contamination by means of intrusive sampling and analysis, for the contaminants of potential concern (COPC). Where contamination was identified, recommendations for further management would be provided. The objective was achieved by completing the following scope of works:

- A desktop study, involving a review of the EI (2017) PSI and existing services onsite;
- A detailed site walkover inspection;
- Multiple level soil samples collected from 30 test pit locations distributed in a systematic grid based pattern (across accessible areas of the site), for the analysis of:
 - Eight priority metals (HMs) being arsenic, cadmium, chromium, copper, lead, mercury nickel and zinc;
 - Total recoverable hydrocarbons (TRH);
 - Polycyclic aromatic hydrocarbons (PAH);
 - Monocyclic aromatic hydrocarbon compounds, benzene, toluene, ethylbenzene and xylenes (BTEX);

- Organochlorine and organophosphate pesticides (OCPs/ OPPs);
- Polychlorinated biphenyls (PCBs); and
- Asbestos presence.
- Data analysis and reporting.

A plan showing the sample locations assessed by EI (2018) is presented as **Figure 2, Attachment A**, at the end of this letter. Of the thirty test pits (TPs) completed, EI advanced 22 TPs within the Stage 2 site on 19 January 2018, as follows:

- TP101 to TP 112, distributed across Stage 2 South;
- TP120, positioned within the footprint of the former sheds, east of Stage 2 North; and
- TP122 to TP130, distributed across Stage 2 North.

The test pits were advanced to the depths of natural soil, being 0.6 to 1.8 metres below ground level (mBGL). No test pits were advanced within the open space area surrounding the southern creek. The site stratigraphy encountered was summarised as a lens of silty sandy topsoil fill (approx. 0.3 m thick) overlying natural silty sandy clay of high plasticity. Extremely weathered shale bedrock was encountered at depths of 1 mBGL. No asbestos containing material (ACM), visual or olfactory signs of contamination were identified.

Due to the number of samples collected, fill soils from selected locations were combined, and analysed as composite samples. Appropriate quality control samples were also collected and analysed. The DSI did not report any concentrations of contaminants above NEPM 2013 health investigation levels (HILs) for residential land with minimal access to soil (HIL B). However, two of the composite samples (C6 and C7) collected from TP121, TP123, TP124, TP126 and TP127 (See **Figure 2, Attachment A**) reported elevated concentrations of zinc (94 and 95 mg/kg consecutively), which exceeded the ecological criteria derived for the composite samples (48 mg/kg). The samples represented the superficial fill (to depths of 0.2 mBGL) within the central part of Stage 2 North, and the reported concentrations were well below the adopted human health (HIL B) criteria. Based on the proposed development (**Section 1.2**), these fill soils would be excavated and removed from the site for construction of the basement and would not be accessible for the end site users. Therefore, the identified exceedance was of low environmental concern, and was unlikely to pose an unacceptable risk to future users of the residential development proposed.

Groundwater was not encountered within any of the TPs advanced, and was expected to be present at depth, within the fractured shale bedrock. EI encountered a thick lens of highly plastic clays overlying the shale bedrock, which would act as a barrier for the underlying aquifer, restricting contaminant migration from the surface (if present). Given the presence of this barrier, the lack of contamination reported within the site and the depth to groundwater, EI considered the risk of groundwater contamination resulting from onsite and offsite sources to be low and acceptable. Therefore, groundwater was not assessed, and was not of environmental concern.

Based on the findings of the investigation, EI (2018) concluded “*soils and groundwater are suitable for the proposed residential land use (with minimal access to soils) and associated open space*”. EI (2018) recommended to:

- Conduct a complete a Hazardous Material Survey (HMS) prior to demolition; and
- Manage the waste disposal of the fill soils during excavation (site preparation).

The DSI was completed in line with appropriate industry standards and quality, as outlined by NSW EPA contaminated land assessment guidelines. The works were accurate and representative of the land within Stage 2, and were relied on for determining the suitability of the site for the proposed use.

4. EI (2020) PSI with Limited Sampling

EI (2020) completed a DSI for a section of land within the southernmost part of Stage 2 South, which was affected by Land Reservation Acquisition. The area of interest was zoned for public open space (Liverpool LEP, 2008) where Maxwell Creek ran through in an east to west direction. Construction of a

future park was indicated by the development plans (SA, 2020), as part of a land swap arrangement for part of Lot 8 DP 1200987. The following scope of works was completed:

- A desktop study, involving a review of the EI (2017), EI (2018) and existing services onsite;
- A detailed site walkover inspection;
- Sampling from 4 test pits distributed in a triangular grid pattern across multiple soil levels within fill and natural soils;
- Laboratory analysis of selected soil samples for relevant analytical parameters based on the site history and field observations collected during the investigation program; and
- The provision of a PSI report.

A plan showing the sample locations assessed by EI (2020) is presented as **Figure 2, Attachment A**, at the end of this letter. EI notes that none of these test pits were positioned within the Stage 2 portion of the site, however the data provides an understanding of the soil quality along the Stage 2 boundary, which can be applied to the south eastern corner (part of Lot 8 DP1200987).

EI (2020) assessed the historical use of the area, and found the land adjacent to Maxwell's Creek to have been largely vacant, and covered by dense trees. The land use activities and COPC were the same as those stated for 361-363 Bernera Road and the intrusive investigations adequately assessed soils for their presence. No concentrations of contaminants were reported to exceed the human health or ecological based criteria for an open space land use. The site was considered suitable for use as a future park.

EI have reviewed the data as presented in **Table 2, Attachment C** and find the data to be well below the Stage 2 criteria for the *residential with minimal access to soil* land use scenario, as well as the ecological criteria adopted for the site.

5. Suitability of Site

EI have reviewed the history of the site and its surroundings (inclusive of part Lot 8 DP 1200987) and concluded that the probability of contamination can be considered to be low. The potential sources of contamination were assessed through the collection of soil samples both within, and surrounding the current Stage 2 development area and did not identify any contamination existing within these areas. Groundwater was not encountered; however, given the low levels of contamination identified, the depth to groundwater and the presence of thick, plastic clays overlying the aquifer, groundwater is considered to be of low environmental concern, and is unlikely to pose a risk to the future use of the land. The sampling completed was in general accordance with the relevant legislation, standards and guidelines in force at the time of the investigations, as required by Section 105 of the *Contaminated Land Management Act 1997*. Data of acceptable quality was collected.

Based on these findings, and subject to the statement of limitations (**Section 8**), EI considers that the Stage 2 development area within Lot 3 DP1259121 & Part Lot 8, DP1200987, Edmondson Park NSW is suitable for a generic, *residential with minimal soil access* and *recreational* land use scenario, and no remediation is required.

6. Recommendations

- Any soil materials being removed from site (including virgin excavated natural materials or VENM) be classified for off-site disposal in accordance the EPA (2014) Waste Classification Guidelines; and
- Any material being imported to the site should be assessed for potential contamination, in accordance with NSW EPA guidelines, as being suitable for the intended use or be classified as virgin excavated natural material (VENM).

7. References

Contaminated Land Management Act 1997.

EI (2017) Preliminary Site Investigation, 190 Croatia Avenue, Edmondson Park NSW. E23243. AA_Rev1, dated 30 November 2017.

EI (2018) Detailed Site Investigation, 190 Croatia Avenue, Edmondson Park NSW, Ref. E23243.E02_Rev0, dated 6 February 2018.

EI (2020) Preliminary Site Investigation with Limited Sampling, part of 190 Croatia Avenue, Edmondson Park NSW, Ref. E23243.E01_Rev0, dated 1 September 2020.

NEPM (2013) Schedule B1 Guideline on Investigation Levels for Soil and Groundwater, Schedule B2 Guideline on Site Characterisation, National Environmental Protection (Assessment of Site Contamination) Measure 1999, National Environmental Protection Council (2013 Amendment).

NSW EPA (2017) Contaminated Land Management: Guidelines for the NSW Site Auditor Scheme, NSW EPA, October 2017.

NSW EPA (2020), Guidelines for Consultants Reporting on Contaminated Land. NSW EPA, April 2020.

Protection of the Environment Operations Act (1997).

SEPP 55 (1997) State Environment Protection Policy 55, Remediation of Land under the Environmental Planning and Assessment Act 1997.

Stansic Architects (SA) (2021), Proposed Residential Development at Lot 3 DP1259121 and Lot 8 DP1200987, Project No. 20 117 issue A, dated 05 May 2021.

For and on behalf of
EI AUSTRALIA PTY LTD

SARI ERU
Senior Environmental Scientist

PEDRO BALBACHEVSKY
Principal Environmental Engineer

8. Statement of Limitations

This review has been prepared for the exclusive use of Croatia 88 Pty Ltd, as the intended beneficiary of EI's work. The scope of the review is limited to those agreed with Aland Developments acting on behalf of the Client, as well as Croatia 88 Pty Ltd.

No other party should rely on the document without the prior written consent of EI, and EI undertakes no duty, or accepts any responsibility or liability, to any third party who purports to rely upon this document without EI's approval.

EI has used a degree of care and skill ordinarily exercised in similar investigations by reputable members of the environmental industry in Australia as at the date of this document. No other warranty, expressed or implied, is made or intended. Each section of this report must be read in conjunction with the whole of this report, including its appendices and attachments.


The conclusions presented in this report are based on a limited investigation of conditions and may include work done by others, with specific sampling locations chosen by Croatia 88 Pty Ltd to be as representative as possible under the given circumstances.

EI's professional opinions are reasonable and based on its professional judgment, experience, training and results from analytical data. EI may also have relied upon information provided by the Client and other third parties to prepare this document, some of which may not have been verified by EI.

EI's professional opinions contained in this document are subject to modification if additional information is obtained through further investigation, observations, or validation testing and analysis during remedial activities. In some cases, further testing and analysis may be required, which may result in a further report with different conclusions.

Attachment A

Figures

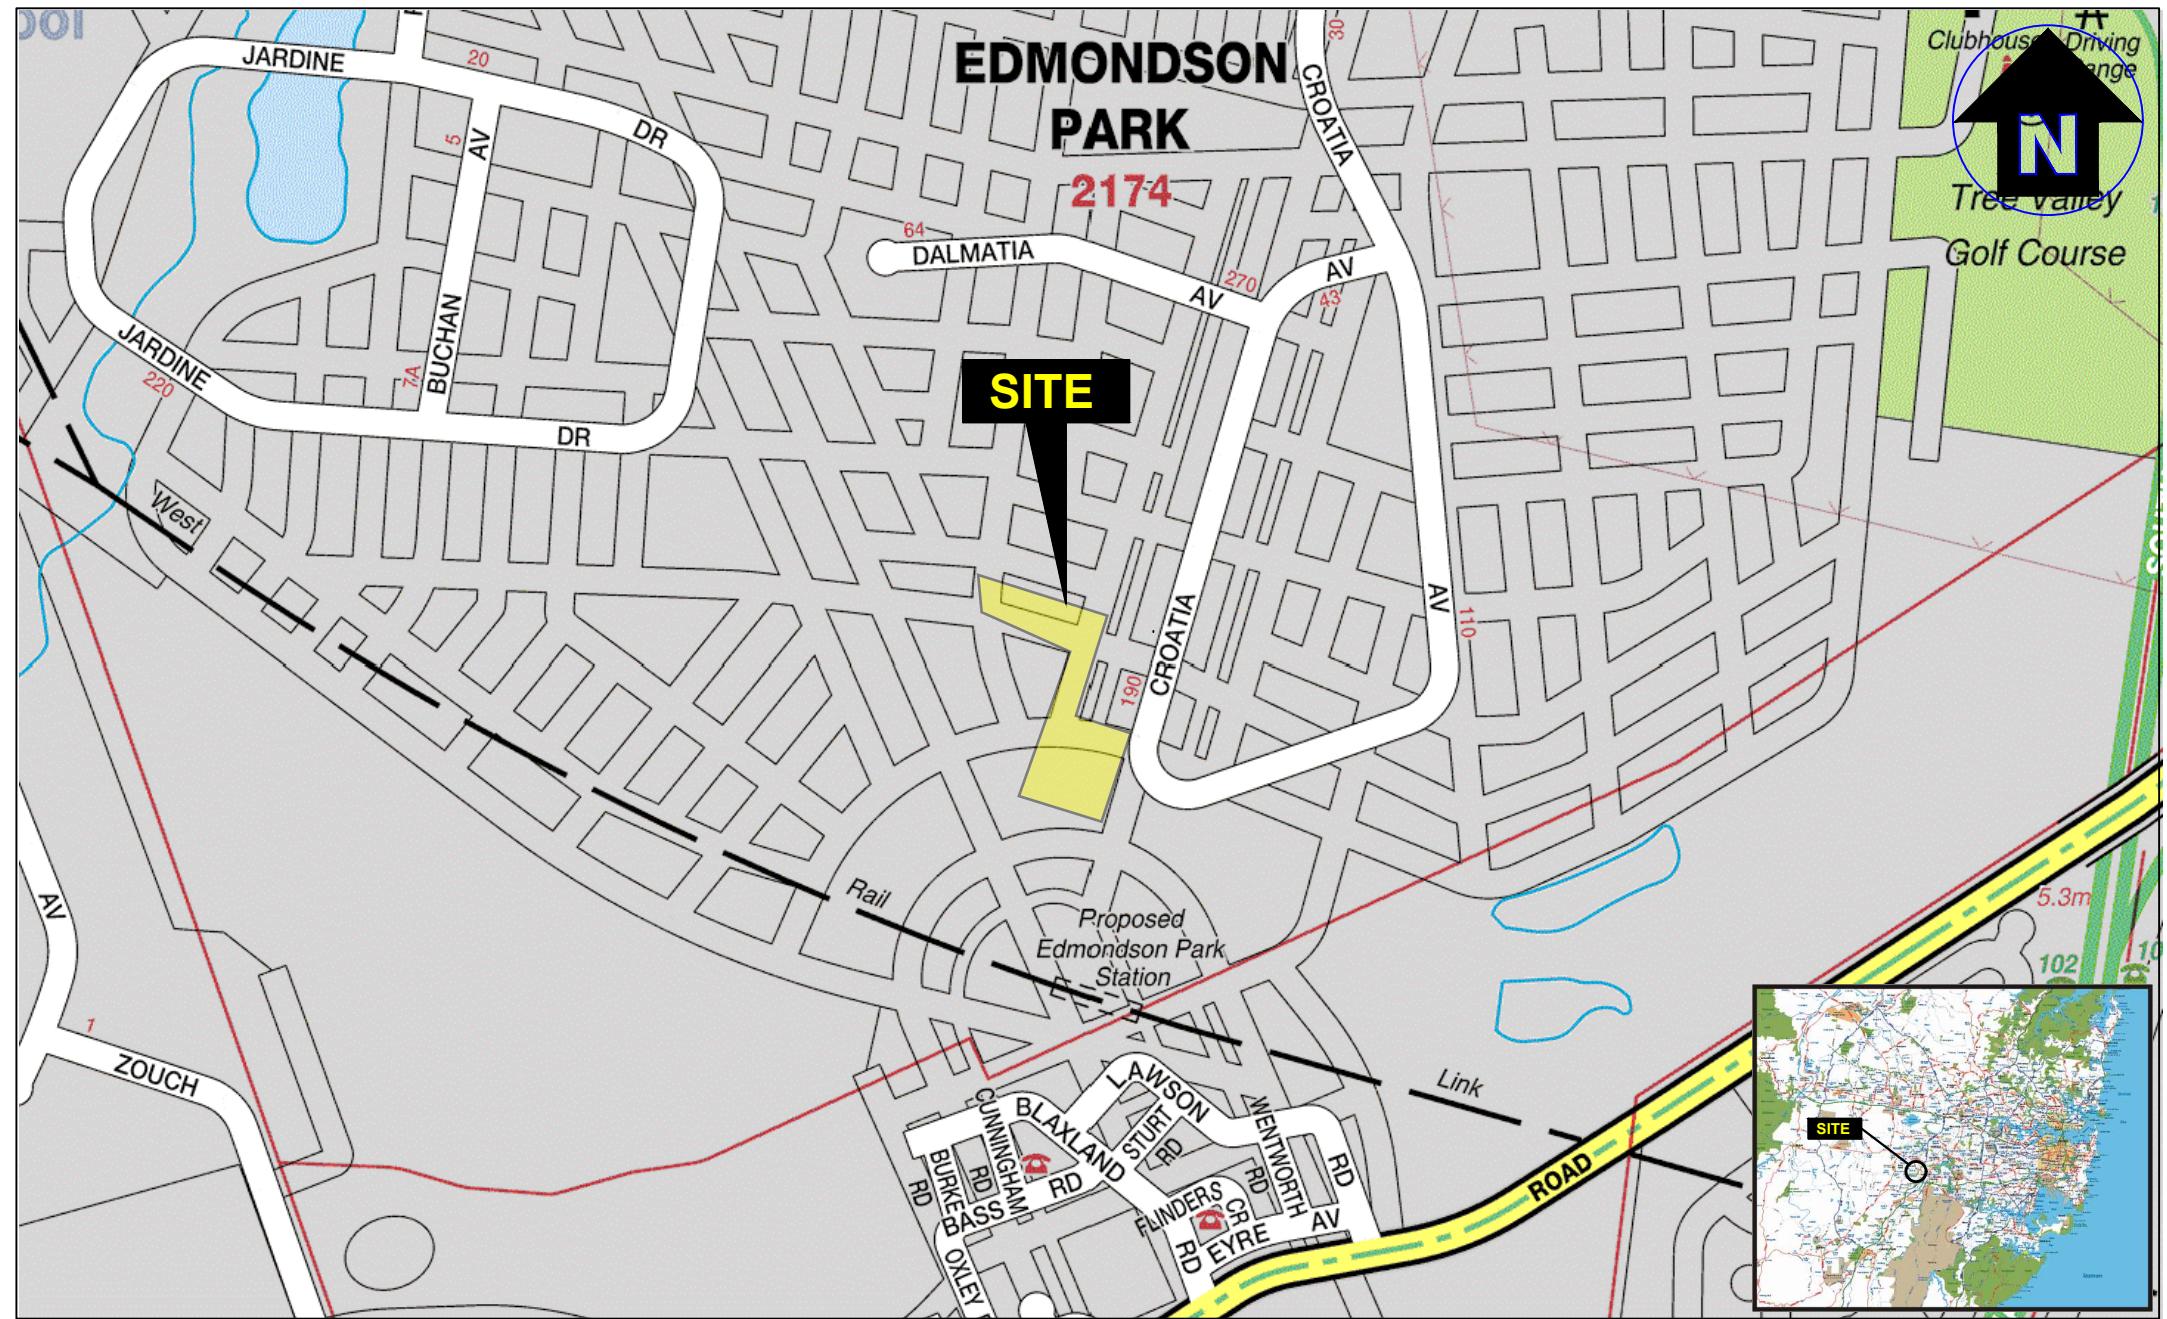


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Drawn:	M.G.
Approved:	S.E.
Date:	22-08-21
Scale:	Not To Scale

Croatia 88 Pty Ltd
Environmental Assessment Review
Lot 3 DP 1259121, Somme Ave & Lot 8 DP 1200987, Croatia Ave
Edmondson Park NSW
Site Locality Plan

Figure: 1

Project: E23243_E99.1

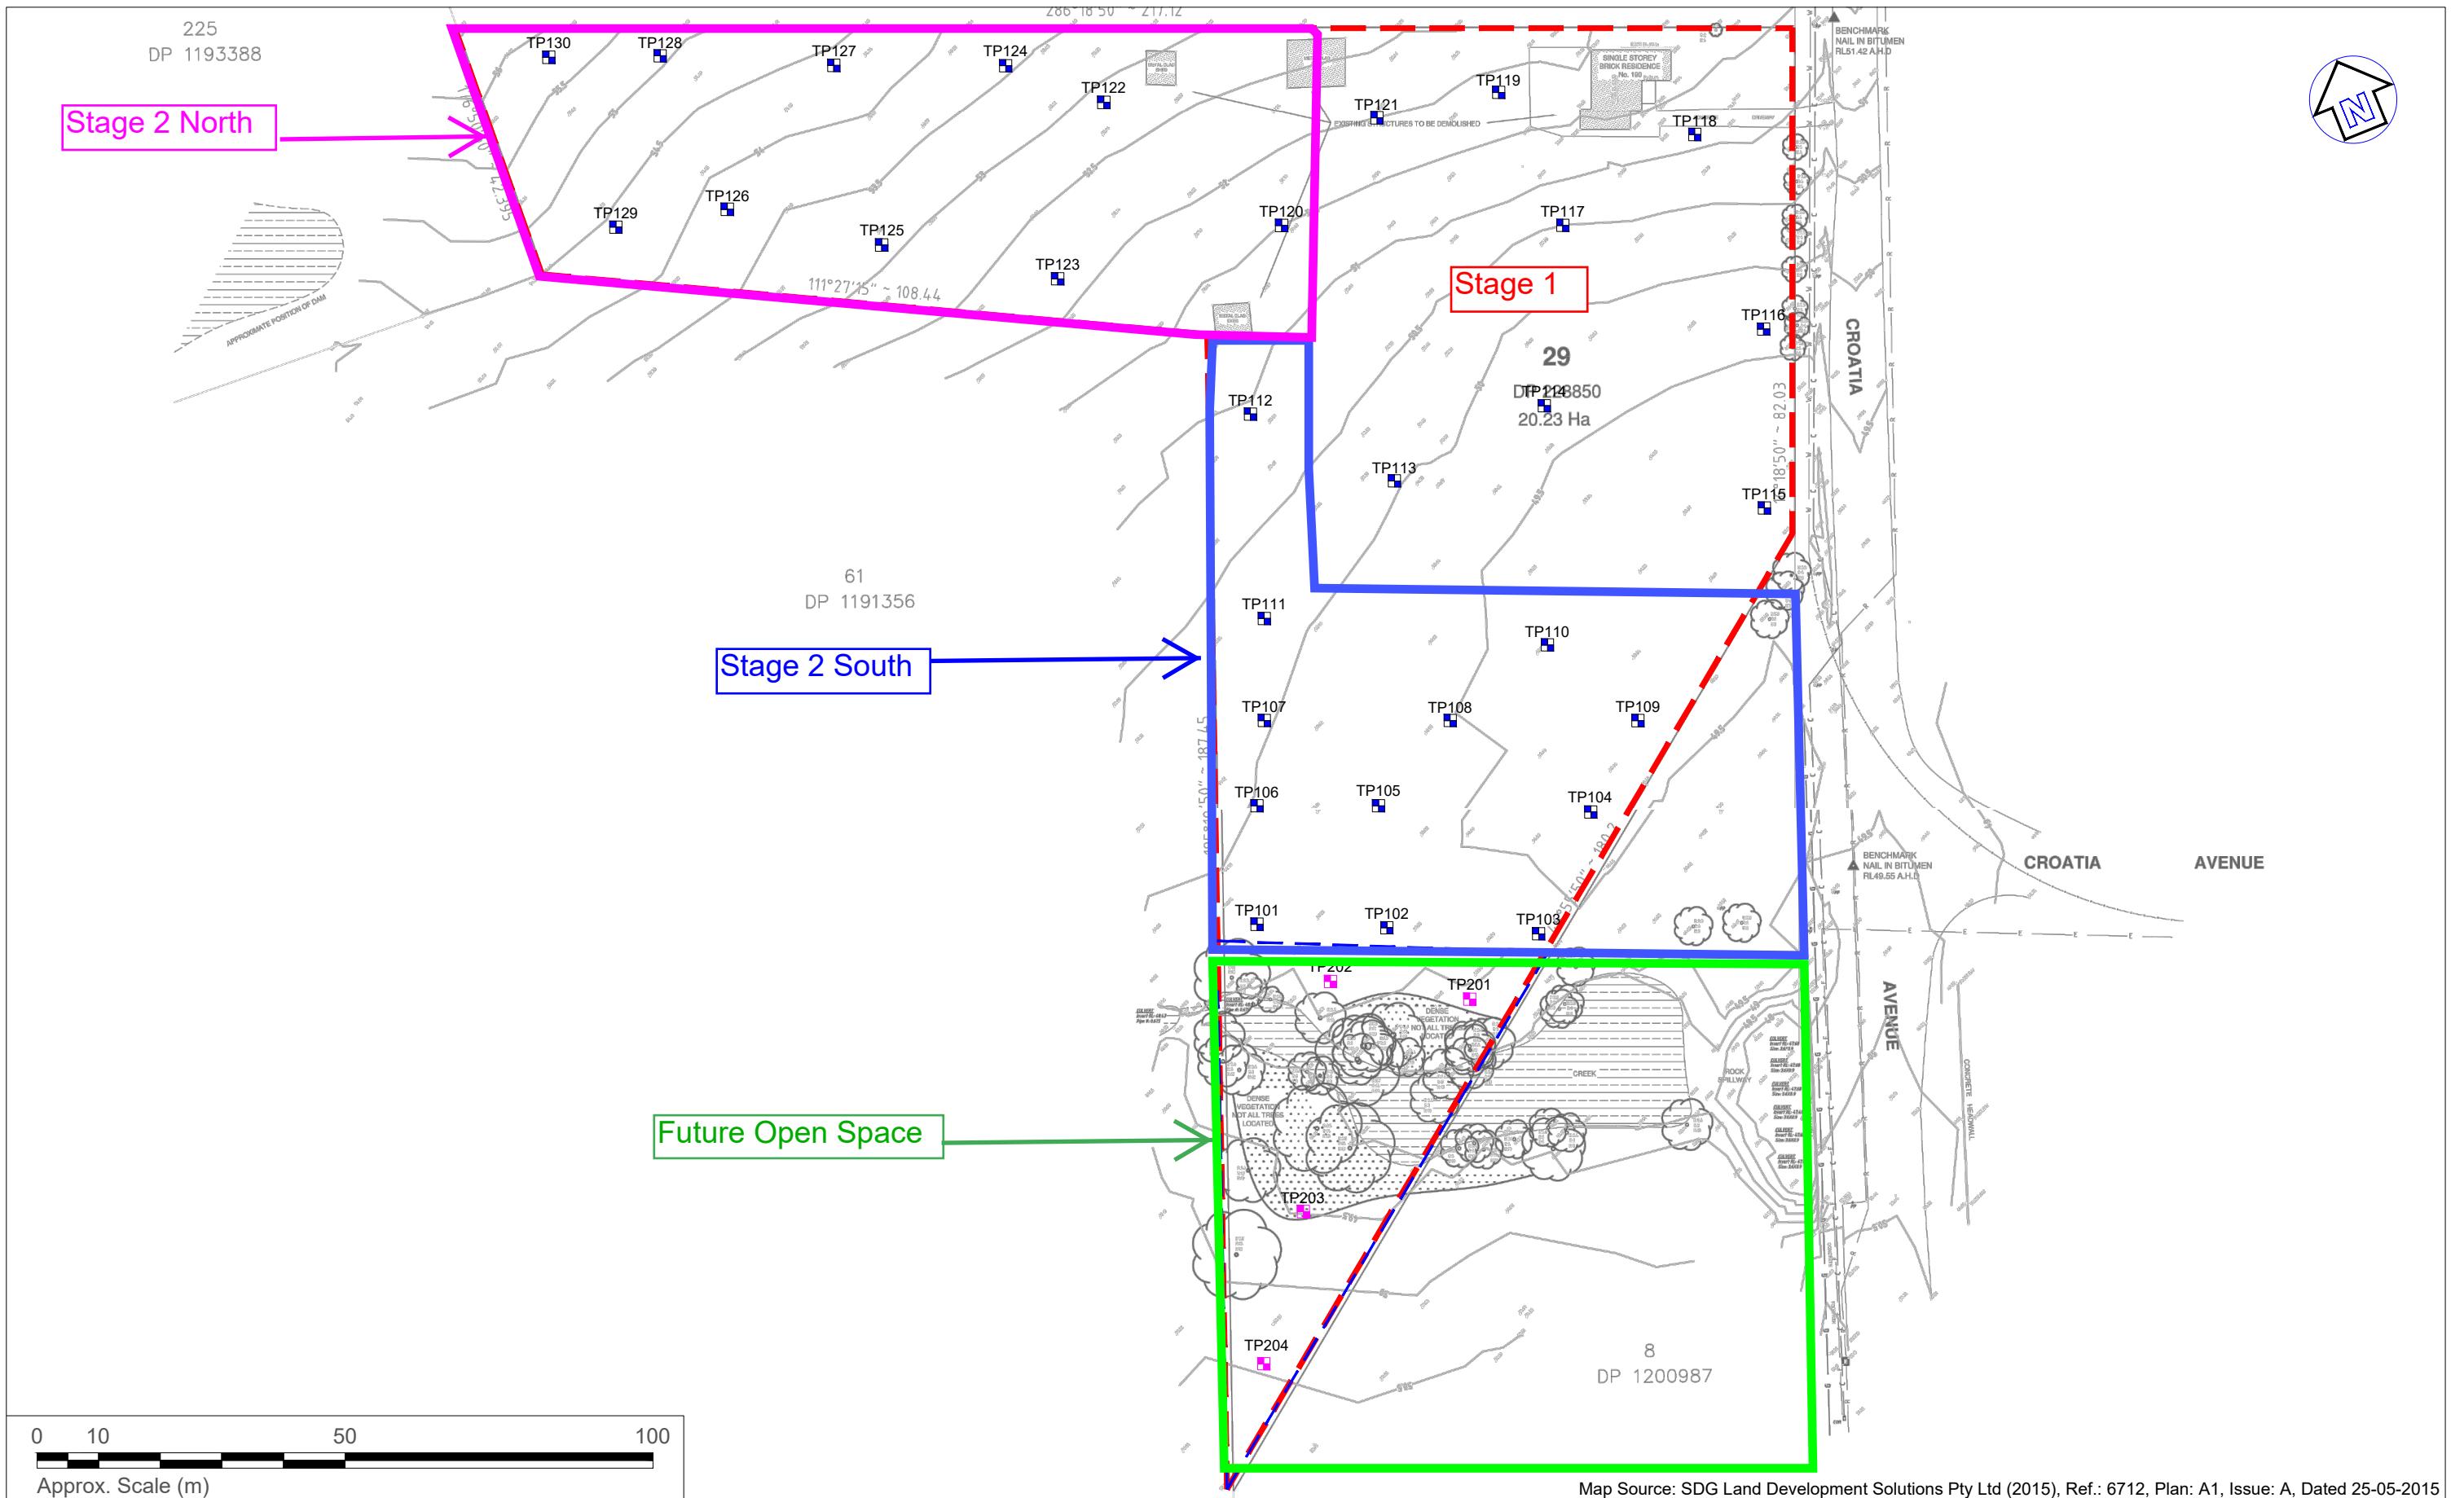

LEGEND (all locations are approximate)

- - - Larger block, former site boundary
- Current Investigation Area
- EI (2018) test pit locations
- EI (2020) test pit locations

Attachment B

Selected Plans of Proposed Development



issue amendment date legend

A ISSUE FOR DEVELOPMENT APPLICATION 03.10.21

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client

CROATIA 88 PTY LTD

architect

RESIDENTIAL APARTMENT DEVELOPMENT

LOT 3 DP1259121 SOMME AVENUE + LOT 8 DP1200987 CROATIA AVENUE EDMONDSON PARK NSW

DEVELOPMENT APPLICATION

DRAWING NO.	DRAWING NAME	REVISION DATE
0000 SERIES: CONTEXT, SITE + DEVELOPMENT DATA		
DA 0001	DRAWING LIST + LOCATION PLAN	A 03.10.21
DA 0002	ACCOMMODATION SCHEDULE	A 03.10.21
DA 0003	DEVELOPMENT DATA	A 03.10.21
DA 0004	CONTEXT ANALYSIS PLAN	A 03.10.21
DA 0005	SITE ANALYSIS PLAN	A 03.10.21
DA 0006	SITE PLAN	A 03.10.21
1000 SERIES: GENERAL ARRANGEMENT PLANS (BLD A+B)		
DA 1001	BASEMENT 2 PLAN	A 03.10.21
DA 1002	LEVEL LG (B1) PLAN - BLD A+B	A 03.10.21
DA 1003	LEVEL 1 (G) PLAN - BLD A+B	A 03.10.21
DA 1004	LEVEL 2 PLAN - BLD A+B	A 03.10.21
DA 1005	LEVEL 3 PLAN - BLD A+B	A 03.10.21
DA 1006	LEVEL 4 PLAN - BLD A+B	A 03.10.21
DA 1007	LEVEL 5 PLAN - BLD A+B	A 03.10.21
DA 1008	ROOF PLAN - BLD A+B	A 03.10.21
1100 SERIES: GENERAL ARRANGEMENT PLANS (BLD C)		
DA 1101	BASEMENT 4 PLAN - BLD C	A 03.10.21
DA 1102	BASEMENT 3 PLAN - BLD C	A 03.10.21
DA 1103	BASEMENT 2 PLAN - BLD C	A 03.10.21
DA 1104	BASEMENT 1 PLAN - BLD C	A 03.10.21
DA 1105	LEVEL 1 (G) PLAN - BLD C	A 03.10.21
DA 1106	LEVEL 2 PLAN - BLD C	A 03.10.21
DA 1107	LEVEL 3 PLAN - BLD C	A 03.10.21
DA 1108	LEVEL 4 PLAN - BLD C	A 03.10.21
DA 1109	LEVEL 5 PLAN - BLD C	A 03.10.21
DA 1110	LEVEL 6 PLAN - BLD C	A 03.10.21
DA 1111	ROOF PLAN - BLD C	A 03.10.21
2000 SERIES: ELEVATIONS + SECTIONS (BLD A+B)		
DA 2001	NORTH + SOUTH ELEVATION (BLD A+B)	A 03.10.21
DA 2002	EAST + WEST ELEVATIONS + SECTIONS (BLD A+B)	A 03.10.21
DA 2003	INTERNAL ELEVATIONS + SECTIONS (BLD A+B)	A 03.10.21
2100 SERIES: ELEVATIONS + SECTIONS (BLD C)		
DA 2101	NORTH + SOUTH ELEVATION (BLD C)	A 03.10.21
DA 2102	EAST + WEST ELEVATION + SECTIONS (BLD C)	A 03.10.21
4000 SERIES: AERIAL VIEWS		
DA 4001	AERIAL VIEW - NORTH	A 03.10.21
DA 4002	AERIAL VIEW - SOUTH	A 03.10.21
5000 SERIES: SUN EYE VIEW DIAGRAMS		
DA 5001	SUN EYE VIEWS - WINTER SOLSTICE (09.00-12.00)	A 03.10.21
DA 5002	SUN EYE VIEWS - WINTER SOLSTICE (13.00-15.00)	A 03.10.21
8000 SERIES: DIAGRAMS		
DA 8001	GFA DIAGRAMS - BLD A+B (SHEET 1)	A 03.10.21
DA 8002	GFA DIAGRAMS - BLD A+B (SHEET 2)	A 03.10.21
DA 8003	GFA DIAGRAMS - BLD C (SHEET 1)	A 03.10.21
DA 8004	GFA DIAGRAMS - BLD C (SHEET 2)	A 03.10.21
DA 8005	SOLAR ACCESS DIAGRAMS - BLD A+B (SHEET 1)	A 03.10.21
DA 8006	SOLAR ACCESS DIAGRAMS - BLD A+B (SHEET 2)	A 03.10.21
DA 8007	SOLAR ACCESS DIAGRAMS - BLD C (SHEET 1)	A 03.10.21
DA 8008	SOLAR ACCESS DIAGRAMS - BLD C (SHEET 2)	A 03.10.21
DA 8009	NATURAL CROSS VENTILATION - BLD A+B (SHEET 1)	A 03.10.21
DA 8010	NATURAL CROSS VENTILATION - BLD A+B (SHEET 2)	A 03.10.21
DA 8011	NATURAL CROSS VENTILATION - BLD C (SHEET 1)	A 03.10.21
DA 8012	NATURAL CROSS VENTILATION - BLD C (SHEET 2)	A 03.10.21
DA 8013	MAXIMUM HOB HEIGHT BLANKET	A 03.10.21
DA 8014	ADAPTABLE + LIVABLE ACCOMMODATION DIAGRAMS (SHEET 1)	A 03.10.21
DA 8015	ADAPTABLE + LIVABLE ACCOMMODATION DIAGRAMS (SHEET 2)	A 03.10.21
DA 8016	OPEN SPACE DIAGRAMS	A 03.10.21
9000 SERIES: EXTERNAL MATERIALS, FINISHES + COLOURS		
DA 9001	EXTERNAL MATERIALS, FINISHES + COLOURS BOARD - BLD A	A 03.10.21
DA 9002	EXTERNAL MATERIALS, FINISHES + COLOURS BOARD - BLD B	A 03.10.21
DA 9003	EXTERNAL MATERIALS, FINISHES + COLOURS BOARD - BLD C	A 03.10.21

north	tn	project	RESIDENTIAL APARTMENT DEVELOPMENT		
			LOT 3 DP1259121 SOMME AVENUE + LOT 8 DP1200987 CROATIA AVENUE EDMONDSON PARK		
			checked	drawing	DRAWING LIST + LOCATION PLAN
scale	1:2000 @ A1 1:4000 @ A3	drawn	JN	issue	A
scale bar	0 20 40 60 80 100 m	project no	20 117	drawing no	DA 0001

ACCOMMODATION SCHEDULE - BUILDING A										
LEVEL	UNIT NO.	BEDS	TYPE	AREA	ADAPTABLE / LIVABLE	NATURAL CROSS VENTILATION	2 HOURS SOLAR ACCESS	APARTMENT STORAGE	BASEMENT STORAGE	
LEVEL 1 (G) - NORTH	A101	1B+ST	B3-2	65 m ²		YES	YES	3m ³	3m ³	
LEVEL 1 (G) - NORTH	A102	2B+2BA	F11-2	78 m ²		NO	YES	4m ³	4m ³	
LEVEL 1 (G) - NORTH	A103	2B+2BA	F2-3	77 m ²	ADAPT/LIV	NO	YES	4m ³	4m ³	
LEVEL 1 (G) - NORTH	A104	2B+2BA	F10	79 m ²		NO	YES	4m ³	4m ³	
LEVEL 1 (G) - NORTH	A106	2B	F18	75 m ²		YES	NO	4m ³	4m ³	
LEVEL 1 (G) - NORTH	A107	1B+ST	B6	59 m ²		NO	NO	3m ³	3m ³	
LEVEL 2 - NORTH	A201	1B+ST	B3-1	65 m ²		YES	YES	3m ³	3m ³	
LEVEL 2 - NORTH	A202	2B+2BA	F11-1	78 m ²		NO	YES	4m ³	4m ³	
LEVEL 2 - NORTH	A203	2B+2BA	F2-2	77 m ²	ADAPT/LIV	NO	YES	4m ³	4m ³	
LEVEL 2 - NORTH	A204	1B	B1	51 m ²	LIV	NO	YES	3m ³	3m ³	
LEVEL 2 - NORTH	A205	2B+2BA	F4	81 m ²		YES	YES	4m ³	4m ³	
LEVEL 2 - NORTH	A206	3B	J1	93 m ²		YES	NO	5m ³	5m ³	
LEVEL 2 - NORTH	A207	1B	B5	51 m ²		YES	YES	3m ³	3m ³	
LEVEL 3 - NORTH	A301	1B+ST	B3-1	65 m ²		YES	YES	3m ³	3m ³	
LEVEL 3 - NORTH	A302	2B+2BA	F11-1	78 m ²		YES	YES	4m ³	4m ³	
LEVEL 3 - NORTH	A303	2B+2BA	F2-2	77 m ²	ADAPT/LIV	YES	YES	4m ³	4m ³	
LEVEL 3 - NORTH	A304	1B	B1	51 m ²	LIV	YES	YES	3m ³	3m ³	
LEVEL 3 - NORTH	A305	2B+2BA	F4	81 m ²		YES	YES	4m ³	4m ³	
LEVEL 3 - NORTH	A306	3B	J1	93 m ²		NO	NO	5m ³	5m ³	
TOTAL: 20				1428 m ²	3 x ADAPT		YES	3m ³	3m ³	
					5 x LIV					

UNIT TYPES - BUILDING A

<input type="checkbox"/> 1 BED
8 (40%)
<input checked="" type="checkbox"/> 2 BED
10 (50%)
<input type="checkbox"/> 3 BED
2 (10%)
Grand total: 20

ACCOMMODATION SCHEDULE - BUILDING B

LEVEL	UNIT NO.	BEDS	TYPE	AREA	ADAPTABLE / LIVABLE	NATURAL CROSS VENTILATION	2 HOURS SOLAR ACCESS	APARTMENT STORAGE	BASEMENT STORAGE	
LEVEL LG (B1) - NORTH	B001	1B	B9	55 m ²		NO	NO	3m ³	3m ³	
LEVEL LG (B1) - NORTH	B002	2B+2BA	F13	83 m ²		YES	NO	4m ³	4m ³	
LEVEL LG (B1) - NORTH	B003	1B	B7	59 m ²		YES	YES	3m ³	3m ³	
LEVEL 1 (G) - NORTH	B101	3B	J2-2	106 m ²	LIV	YES	YES	5m ³	5m ³	
LEVEL 1 (G) - NORTH	B102	2B+2BA	F5-2	89 m ²		YES	YES	4m ³	4m ³	
LEVEL 1 (G) - NORTH	B103	2B+2BA	F1-1	82 m ²		NO	YES	4m ³	4m ³	
LEVEL 1 (G) - NORTH	B104	2B+2BA	F2-1	78 m ²		NO	YES	4m ³	4m ³	
LEVEL 1 (G) - NORTH	B105	1B	B1	51 m ²	LIV	NO	YES	3m ³	3m ³	
LEVEL 1 (G) - NORTH	B106	2B	B14	78 m ²	ADAPT/LIV	YES	YES	4m ³	4m ³	
LEVEL 1 (G) - NORTH	B107	1B	B3-1	57 m ²		NO	NO	3m ³	3m ³	
LEVEL 1 (G) - NORTH	B108	2B+2BA	F3-1	77 m ²		NO	NO	4m ³	4m ³	
LEVEL 1 (G) - NORTH	B109	2B+2BA	F17	75 m ²		YES	NO	4m ³	4m ³	
LEVEL 1 (G) - NORTH	B110	2B	F6-2	75 m ²		YES	YES	4m ³	4m ³	
LEVEL 1 (G) - NORTH	B111	2B+2BA	F3-2	77 m ²		NO	NO	4m ³	4m ³	
LEVEL 2 - NORTH	B201	3B	J2-1	105 m ²	LIV	YES	YES	5m ³	5m ³	
LEVEL 2 - NORTH	B202	2B+2BA	F5-1	83 m ²		YES	YES	4m ³	4m ³	
LEVEL 2 - NORTH	B203	2B+2BA	F1-1	82 m ²		NO	YES	4m ³	4m ³	
LEVEL 2 - NORTH	B204	2B+2BA	F2-1	78 m ²		NO	YES	4m ³	4m ³	
LEVEL 2 - NORTH	B205	1B	B1-1	51 m ²	LIV	NO	YES	3m ³	3m ³	
LEVEL 2 - NORTH	B206	2B	B14	70 m ²	ADAPT/LIV	YES	YES	4m ³	4m ³	
LEVEL 2 - NORTH	B207	1B	B2-1	57 m ²		NO	NO	3m ³	3m ³	
LEVEL 2 - NORTH	B208	2B+2BA	F3-1	77 m ²		NO	NO	4m ³	4m ³	
LEVEL 2 - NORTH	B209	2B+2BA	F17	75 m ²		YES	NO	4m ³	4m ³	
LEVEL 2 - NORTH	B210	2B	F6-1	75 m ²		YES	YES	4m ³	4m ³	
LEVEL 2 - NORTH	B211	2B+2BA	F3-3	79 m ²		NO	YES	4m ³	4m ³	
LEVEL 3 - NORTH	B301	3B	J2-1	105 m ²	LIV	YES	YES	5m ³	5m ³	
LEVEL 3 - NORTH	B302	2B+2BA	F5-1	88 m ²		YES	YES	4m ³	4m ³	
LEVEL 3 - NORTH	B303	2B+2BA	F1-1	82 m ²		YES	YES	4m ³	4m ³	
LEVEL 3 - NORTH	B304	2B+2BA	F2-1	78 m ²		YES	YES	4m ³	4m ³	
LEVEL 3 - NORTH	B305	1B	B1-1	51 m ²	LIV	YES	YES	3m ³	3m ³	
LEVEL 3 - NORTH	B306	2B	B14	70 m ²	ADAPT/LIV	YES	YES	4m ³	4m ³	
LEVEL 3 - NORTH	B307	1B	B2-1	57 m ²		NO	NO	3m ³	3m ³	
LEVEL 3 - NORTH	B308	2B+2BA	F3-1	77 m ²		NO	NO	4m ³	4m ³	
LEVEL 3 - NORTH	B309	2B+2BA	F17	75 m ²		YES	NO	4m ³	4m ³	
LEVEL 3 - NORTH	B310	2B	F6-1	75 m ²		YES	YES	4m ³	4m ³	
LEVEL 3 - NORTH	B311	2B+2BA	F3-3	79 m ²		NO	YES	4m ³	4m ³	
LEVEL 4 - NORTH	B401	1B	B2-2	56 m ²		YES	YES	3m ³	3m ³	
LEVEL 4 - NORTH	B402	2B+2BA	F3-1	77 m ²		NO	NO	4m ³	4m ³	
LEVEL 4 - NORTH	B403	2B+2BA	F17	75 m ²		YES	NO	4m ³	4m ³	
LEVEL 4 - NORTH	B404	2B+2BA	F2-1	78 m ²		NO	NO	4m ³	4m ³	
LEVEL 4 - NORTH	B405	2B+2BA	F3-3	78 m ²		NO	YES	4m ³	4m ³	
LEVEL 5 - NORTH	B501	1B	B2-2	56 m ²		YES	YES	3m ³	3m ³	
LEVEL 5 - NORTH	B502	2B+2BA	F3-1	77 m ²		YES	YES	4m ³	4m ³	
LEVEL 5 - NORTH	B503	2B+2BA	F17	75 m ²		YES	YES	4m ³	4m ³	
LEVEL 5 - NORTH	B504	2B	F6-1	75 m ²		YES	YES	4m ³	4m ³	
LEVEL 5 - NORTH	B505	2B+2BA	F3-3	79						

PARKING SCHEDULE BUILDING A+B

LEVEL	TYPE	NO.
BASEMENT 2 - NORTH	RESIDENTIAL - 2500 x 5500	64
64		
LEVEL LG (B1) - NORTH	LOADING BAY/VISITOR	1
LEVEL LG (B1) - NORTH	RESIDENTIAL - 2500 x 5500	21
LEVEL LG (B1) - NORTH	RESIDENTIAL ACCESSIBLE - 2500 x 5500	7
LEVEL LG (B1) - NORTH	RESIDENTIAL VISITOR - 2500 x 5500	15
LEVEL LG (B1) - NORTH	RESIDENTIAL VISITOR ACCESSIBLE - 2500 x 5500	1
45		
109		

PARKING SCHEDULE BUILDING C

LEVEL	TYPE	NO.
BASEMENT 4 - SOUTH	RESIDENTIAL 5400 x 2500 PARALLEL	3
BASEMENT 4 - SOUTH	RESIDENTIAL (TANDEM) - 2400 x 5500	5
BASEMENT 4 - SOUTH	RESIDENTIAL - 2500 x 5500	33
41		
BASEMENT 3 - SOUTH	RESIDENTIAL 5400 x 2500 PARALLEL	2
BASEMENT 3 - SOUTH	RESIDENTIAL (TANDEM) - 2400 x 5500	5
BASEMENT 3 - SOUTH	RESIDENTIAL - 2500 x 5500	29
36		
BASEMENT 2 - SOUTH	RESIDENTIAL 5400 x 2500 PARALLEL	2
BASEMENT 2 - SOUTH	RESIDENTIAL (TANDEM) - 2400 x 5500	5
BASEMENT 2 - SOUTH	RESIDENTIAL - 2500 x 5500	18
BASEMENT 2 - SOUTH	RESIDENTIAL ACCESSIBLE - 2500 x 5500	7
32		
BASEMENT 1 - SOUTH	LOADING BAY/VISITOR	1
BASEMENT 1 - SOUTH	RESIDENTIAL 5400 x 2500	3
BASEMENT 1 - SOUTH	RESIDENTIAL 5400 x 2500 PARALLEL	1
BASEMENT 1 - SOUTH	RESIDENTIAL ACCESSIBLE - 2500 x 5500	1
BASEMENT 1 - SOUTH	RESIDENTIAL VISITOR - 2500 x 5500	16
BASEMENT 1 - SOUTH	RESIDENTIAL VISITOR ACCESSIBLE - 2500 x 5500	1
23		
132		

PARKING SCHEDULE BUILDING A+B (BY TYPE)

TYPE	NO.
LOADING BAY/VISITOR	1
RESIDENTIAL - 2500 x 5500	85
RESIDENTIAL ACCESSIBLE - 2500 x 5500	7
RESIDENTIAL VISITOR - 2500 x 5500	15
RESIDENTIAL VISITOR ACCESSIBLE - 2500 x 5500	1
109	

PARKING SCHEDULE BUILDING C (BY TYPE)

TYPE	NO.
LOADING BAY/VISITOR	1
RESIDENTIAL 5400 x 2500	3
RESIDENTIAL 5400 x 2500 PARALLEL	8
RESIDENTIAL (TANDEM) - 2400 x 5500	15
RESIDENTIAL - 2500 x 5500	80
RESIDENTIAL ACCESSIBLE - 2500 x 5500	8
RESIDENTIAL VISITOR - 2500 x 5500	16
RESIDENTIAL VISITOR ACCESSIBLE - 2500 x 5500	1
132	

DCP MINIMUM CAR PARKING RATES:		
1 BED	1	
2 BED	1.5	
3 BED	2	
RESIDENTIAL VISITOR	1/4	
ADAPTABLE	10%	
BUILDING A + B CAR PARKING REQUIRED:		
1 BED x 21	21	
2 BED x 40	60	91
3 BED x 5	10	
RESIDENTIAL VISITOR	16.5 (17)	
TOTAL	108	
ADAPTABLE	6.6(7)	
BUILDING C CAR PARKING REQUIRED:		
1 BED x 16	16	
2 BED x 49	73.5 (74)	102
3 BED x 6	12	
RESIDENTIAL VISITOR	17.75 (18)	
TOTAL	120	
ADAPTABLE	7.1 (8)	

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A ISSUE FOR DEVELOPMENT APPLICATION 03.10.21

ADAPTABLE APARTMENT SCHEDULE

UNIT NO.	LEVEL	TYPE	ADAPTABLE / LIVABLE
B306	LEVEL 3 - NORTH	B14	ADAPT/LIV
B106	LEVEL 1 (G) - NORTH	B14	ADAPT/LIV
B206	LEVEL 2 - NORTH	B14	ADAPT/LIV
C101	LEVEL 1 (G) - SOUTH	F1-3	ADAPT/LIV
A203	LEVEL 2 - NORTH	F2-2	ADAPT/LIV
A303	LEVEL 3 - NORTH	F2-2	ADAPT/LIV
A103	LEVEL 1 (G) - NORTH	F2-3	ADAPT/LIV
C208	LEVEL 2 - SOUTH	F2-4	ADAPT/LIV
C203	LEVEL 2 - SOUTH	F2-4	ADAPT/LIV
C308	LEVEL 3 - SOUTH	F2-4	ADAPT/LIV
C408	LEVEL 4 - SOUTH	F2-4	ADAPT/LIV
C403	LEVEL 4 - SOUTH	F2-4	ADAPT/LIV
C502	LEVEL 5 - SOUTH	F2-4	ADAPT/LIV

TOTAL: 14
ADAPTABLE APARTMENTS 14/137 (10.2%)

LIVABLE APARTMENT SCHEDULE


UNIT NO.	TYPE	LEVEL	ADAPTABLE / LIVABLE
A204	B1	LEVEL 2 - NORTH	LIV
A304	B1	LEVEL 3 - NORTH	LIV
B305	B1-1	LEVEL 3 - NORTH	LIV
B105	B1-1	LEVEL 1 (G) - NORTH	LIV
B205	B1-1	LEVEL 2 - NORTH	LIV
C201	B8-1	LEVEL 2 - SOUTH	LIV
C301	B8-1	LEVEL 3 - SOUTH	LIV
C401	B8-1	LEVEL 4 - SOUTH	LIV
C112	B8-2	LEVEL 1 (G) - SOUTH	LIV
B306	B14	LEVEL 3 - NORTH	ADAPT/LIV
B106	B14	LEVEL 1 (G) - NORTH	ADAPT/LIV
B206	B14	LEVEL 2 - NORTH	ADAPT/LIV
C113	B15	LEVEL 1 (G) - SOUTH	LIV
C101	F1-3	LEVEL 1 (G) - SOUTH	ADAPT/LIV
A203	F2-2	LEVEL 2 - NORTH	ADAPT/LIV
A303	F2-2	LEVEL 3 - NORTH	ADAPT/LIV
A103	F2-3	LEVEL 1 (G) - NORTH	ADAPT/LIV
C208	F2-4	LEVEL 2 - SOUTH	ADAPT/LIV
C203	F2-4	LEVEL 2 - SOUTH	ADAPT/LIV
C308	F2-4	LEVEL 3 - SOUTH	ADAPT/LIV
C303	F2-4	LEVEL 3 - SOUTH	ADAPT/LIV
C408	F2-4	LEVEL 4 - SOUTH	ADAPT/LIV
C403	F2-4	LEVEL 4 - SOUTH	ADAPT/LIV
C502	F2-4	LEVEL 5 - SOUTH	LIV
C602	F2-4	LEVEL 6 - SOUTH	LIV
C202	F9-1	LEVEL 2 - SOUTH	LIV
C302	F9-1	LEVEL 3 - SOUTH	LIV
C402	F9-1	LEVEL 4 - SOUTH	LIV
C501	F9-1	LEVEL 5 - SOUTH	LIV
B301	J2-1	LEVEL 3 - NORTH	LIV
B201	J2-1	LEVEL 2 - NORTH	LIV
B101	J2-2	LEVEL 1 (G) - NORTH	LIV

LIVABLE APARTMENTS 33/137 (24.0%)
FOR LIVABLE APARTMENT DETAILS - REFER TO 1000 SERIES: GA PLANS

GFA SCHEDULE

LEVEL	GFA (m ²)
BUILDING A:	
LEVEL 1 (G) - NORTH	551.61
LEVEL 2 - NORTH	587.52
LEVEL 3 - NORTH	587.52
	1726.65
BUILDING B (0.75:1 PORTION):	
LEVEL LG (B1) - NORTH	79.66
LEVEL 1 (G) - NORTH	729.15
LEVEL 2 - NORTH	717.98
LEVEL 3 - NORTH	729.41
LEVEL 4 - NORTH	160.44
LEVEL 5 - NORTH	160.44
	2577.09
BUILDING B (1.5:1 PORTION):	
LEVEL LG (B1) - NORTH	200.21
LEVEL 1 (G) - NORTH	260.04
LEVEL 2 - NORTH	260.53
LEVEL 3 - NORTH	260.53
LEVEL 4 - NORTH	260.53
LEVEL 5 - NORTH	260.53
	1502.39

BUILDING C:	
LEVEL 1 (G) - SOUTH	937.14
LEVEL 2 - SOUTH	1197.03
LEVEL 3 - SOUTH	1200.07
LEVEL 4 - SOUTH	1197.47
LEVEL 5 - SOUTH	1143.73
LEVEL 6 - SOUTH	572.42
	6247.86
PROPOSED BLENDED GFA	12053.99
PROPOSED BLENDED FSR	1.192:1
PROPOSED GFA (0.75:1 PORTION)	4303.74m ²
PROPOSED GFA (1.5:1 PORTION)	7750.25m ²
PROPOSED FSR (0.75:1 PORTION)	1.09:1
PROPOSED FSR (1.5:1 PORTION)	1.26:1
TOTAL DEVELOPMENT SITE AREA:	
SITE AREA - NORTH (0.75:1)	10111.5 m ²
SITE AREA - SOUTH (1.5:1)	3948.5 m ²
(EXCLUDES ROAD WIDENING + RE1 LAND)	6163 m ²
MAXIMUM PERMISSIBLE GFA	12205.88 m ²
MAXIMUM	

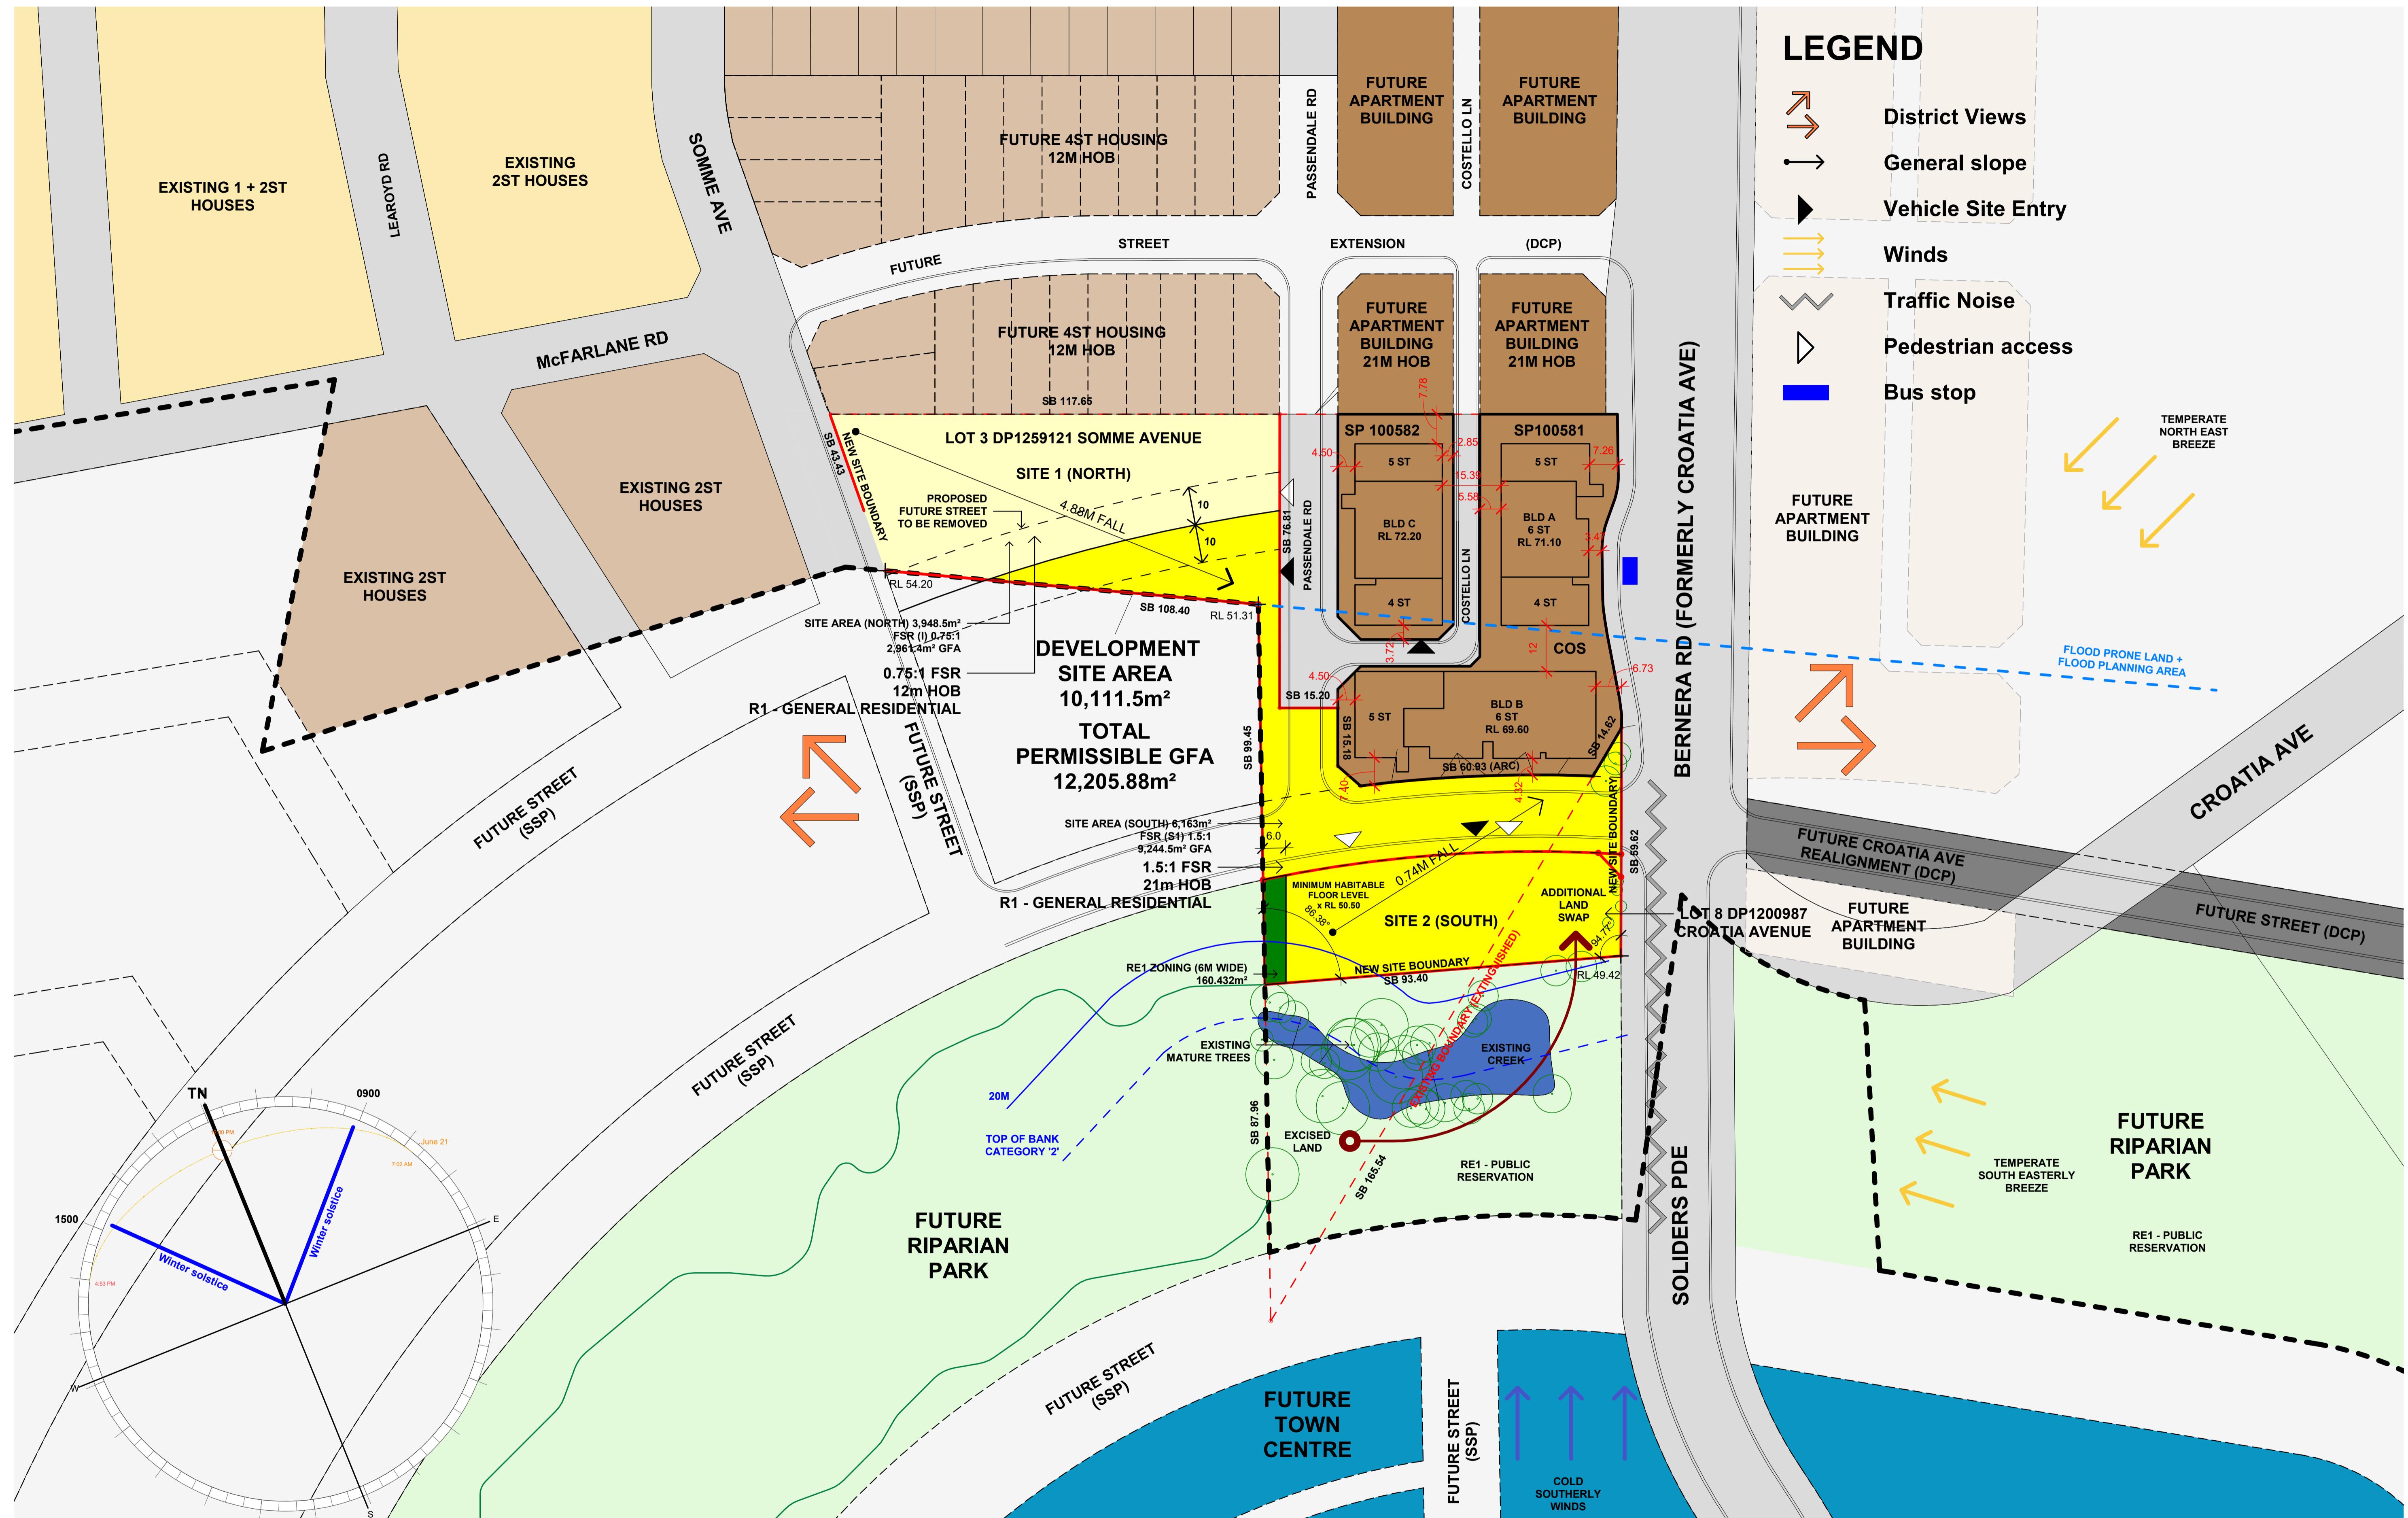

issue amendment

A ISSUE FOR DEVELOPMENT APPLICATION

 Suburban Housing

 State Significant Precip

High School/ Primary S

Train line

 Site

Page 1 of 1

 DA Submitted/ Approved

(SP) RE1 Zoning

— Existing Boundary Extinguished

 Edmondson Park LEP/ DCP Bour

Existing Creek

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project
RESIDENTIAL APARTMENT DEVELOPMENT
LOT 3 DP1259121 SOMME AVENUE + LOT 8 DP1200987 CROATIA AVENUE

EDMONDSON PARK
SITE ANALYSIS PLAN

FS

1:1600@A3 JN A
scale bar 0 8 16 24 32 40 project no drawing no 20-117 DA 0005

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issue amendment
A ISSUE FOR DEVELOPMENT APPLICATION

date
03.10.21

legend

Bx Bedroom
Bx Balcony
C AL Courtyard
C Dining room
EN Ensuite
K Kitchen
L Living room
LD Laundry
P Pantry
R Wardrobe
S Storage
STY Study
T Terrace

architect

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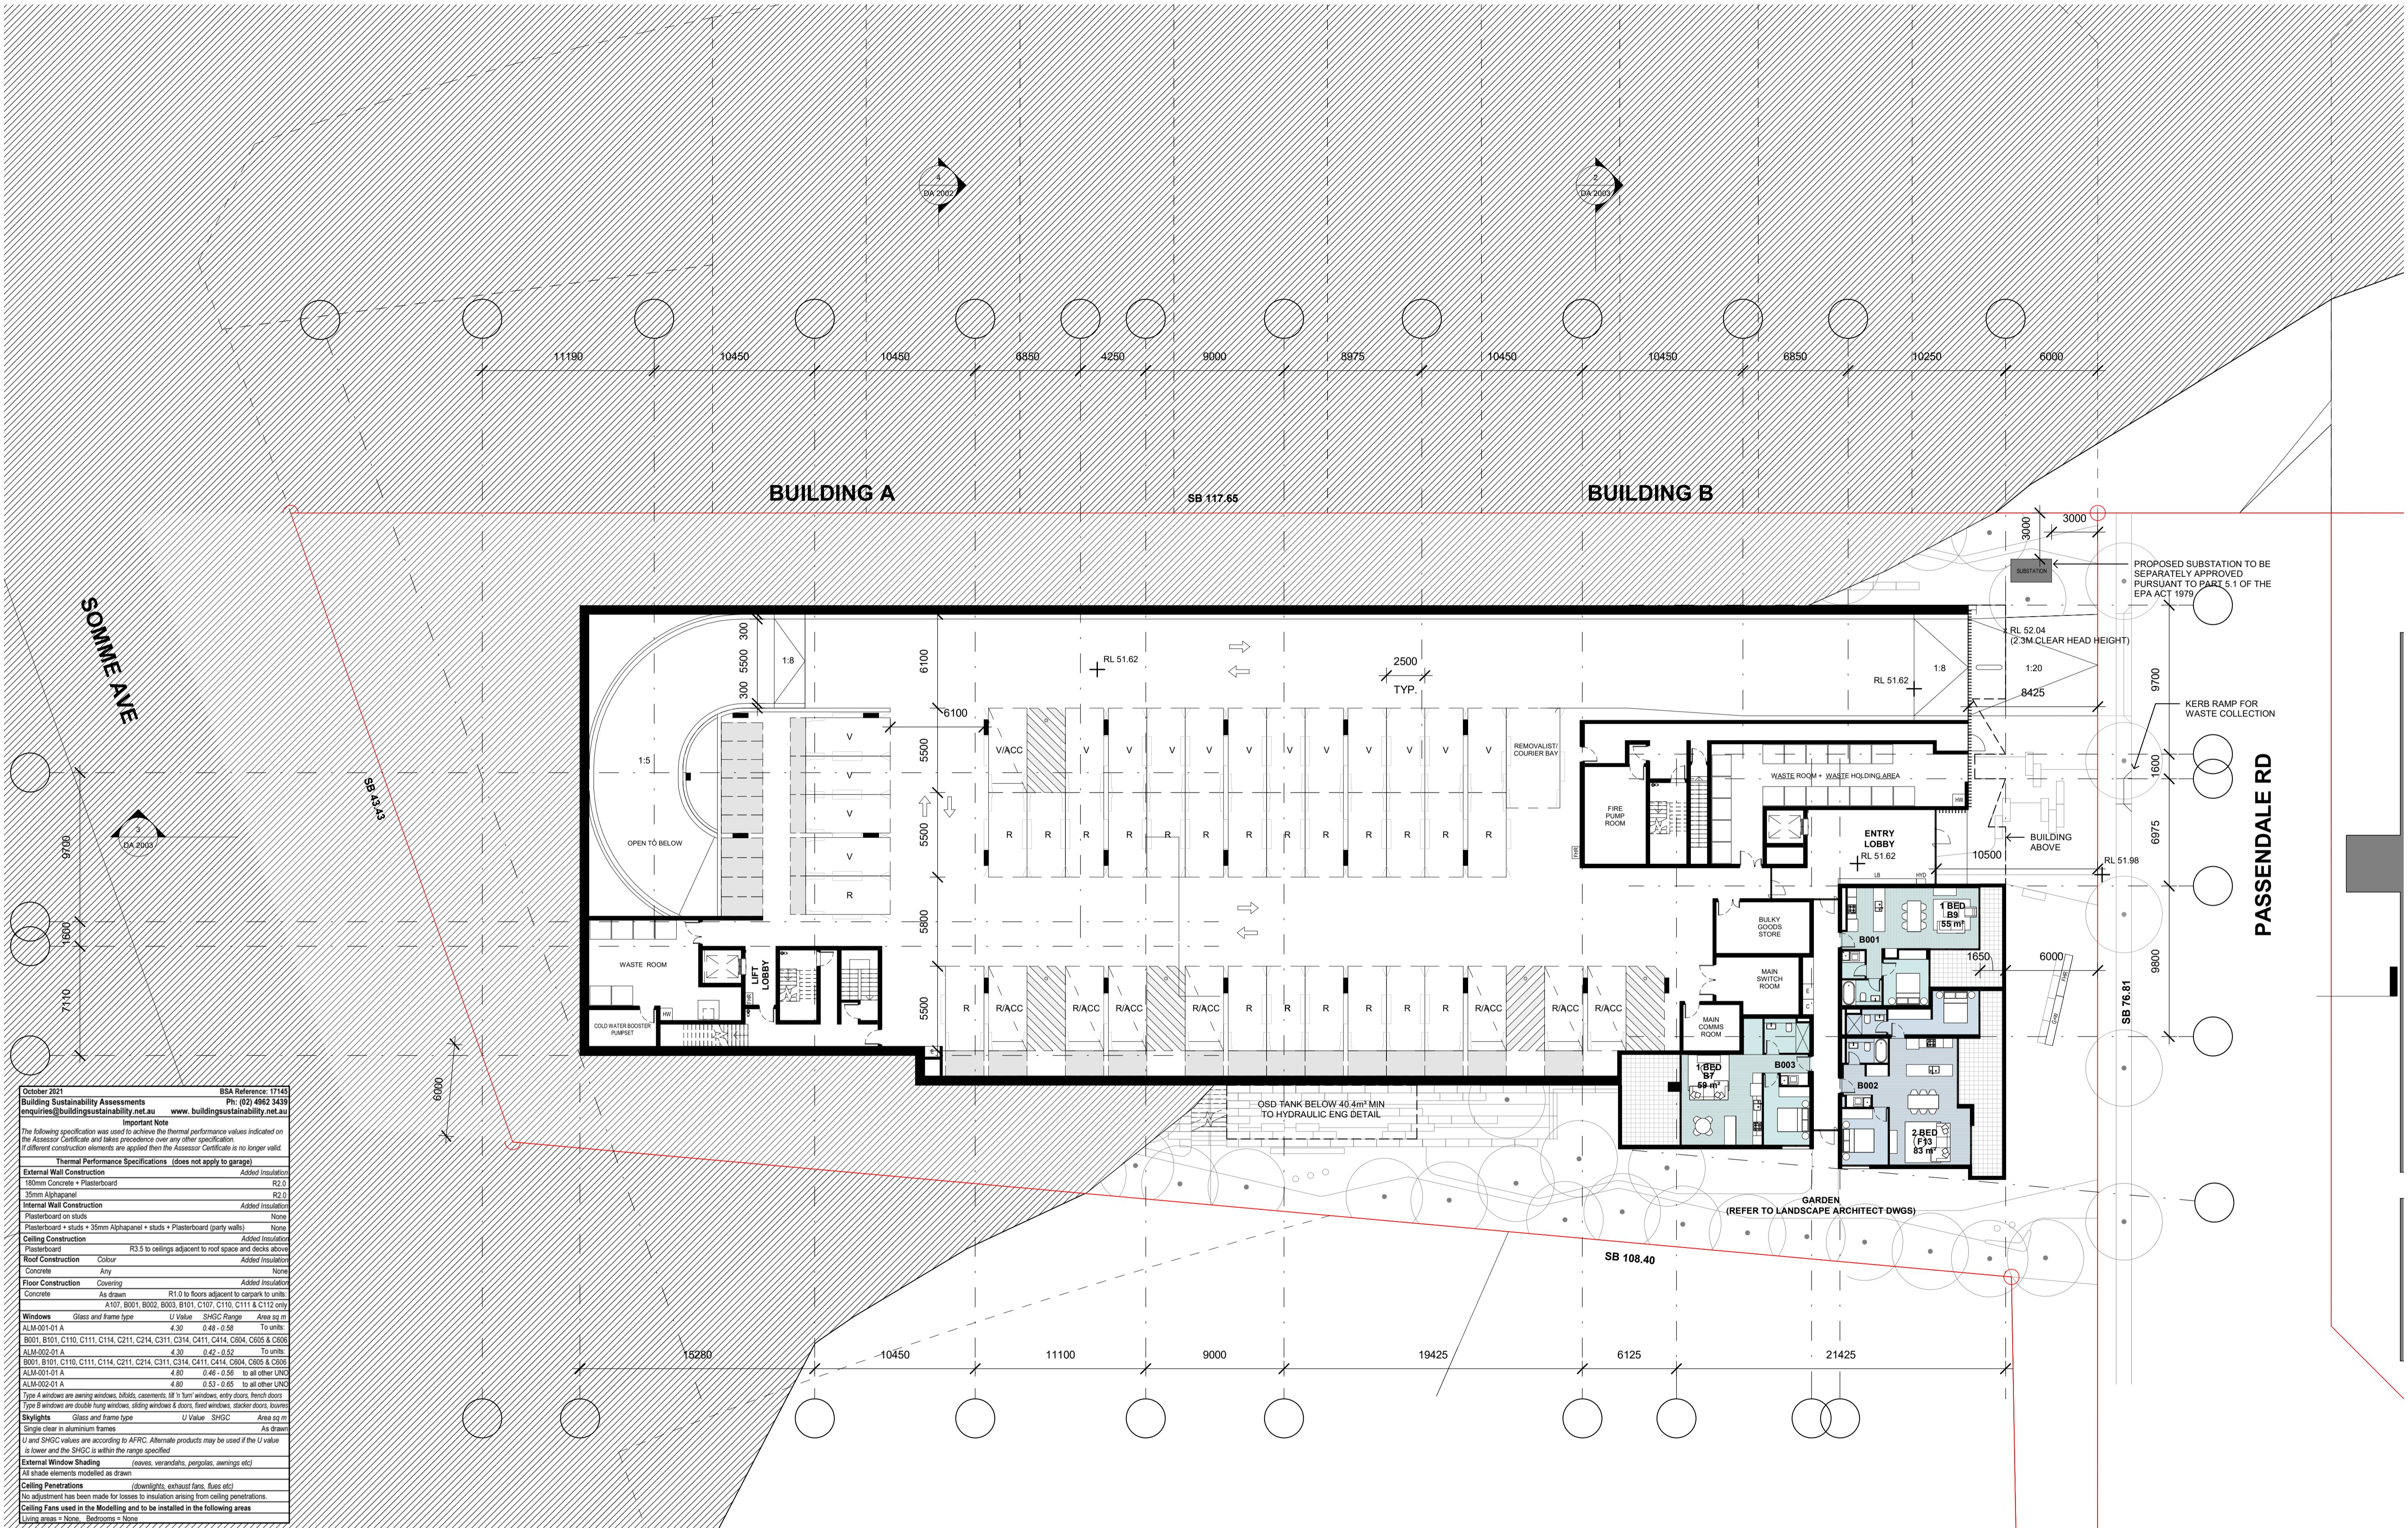
client
CROATIA 88 PTY LTD

RESIDENTIAL APARTMENT DEVELOPMENT
LOT 3 DP1259121 SOMME AVENUE + LOT 8 DP1200987 CROATIA AVENUE
EDMONDSON PARK

SITE PLAN

checked
FS
drawing
1:800@A1
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scale bar
0 8 16 24 32 40 m
project no
20 117
drawing no

DA 0006



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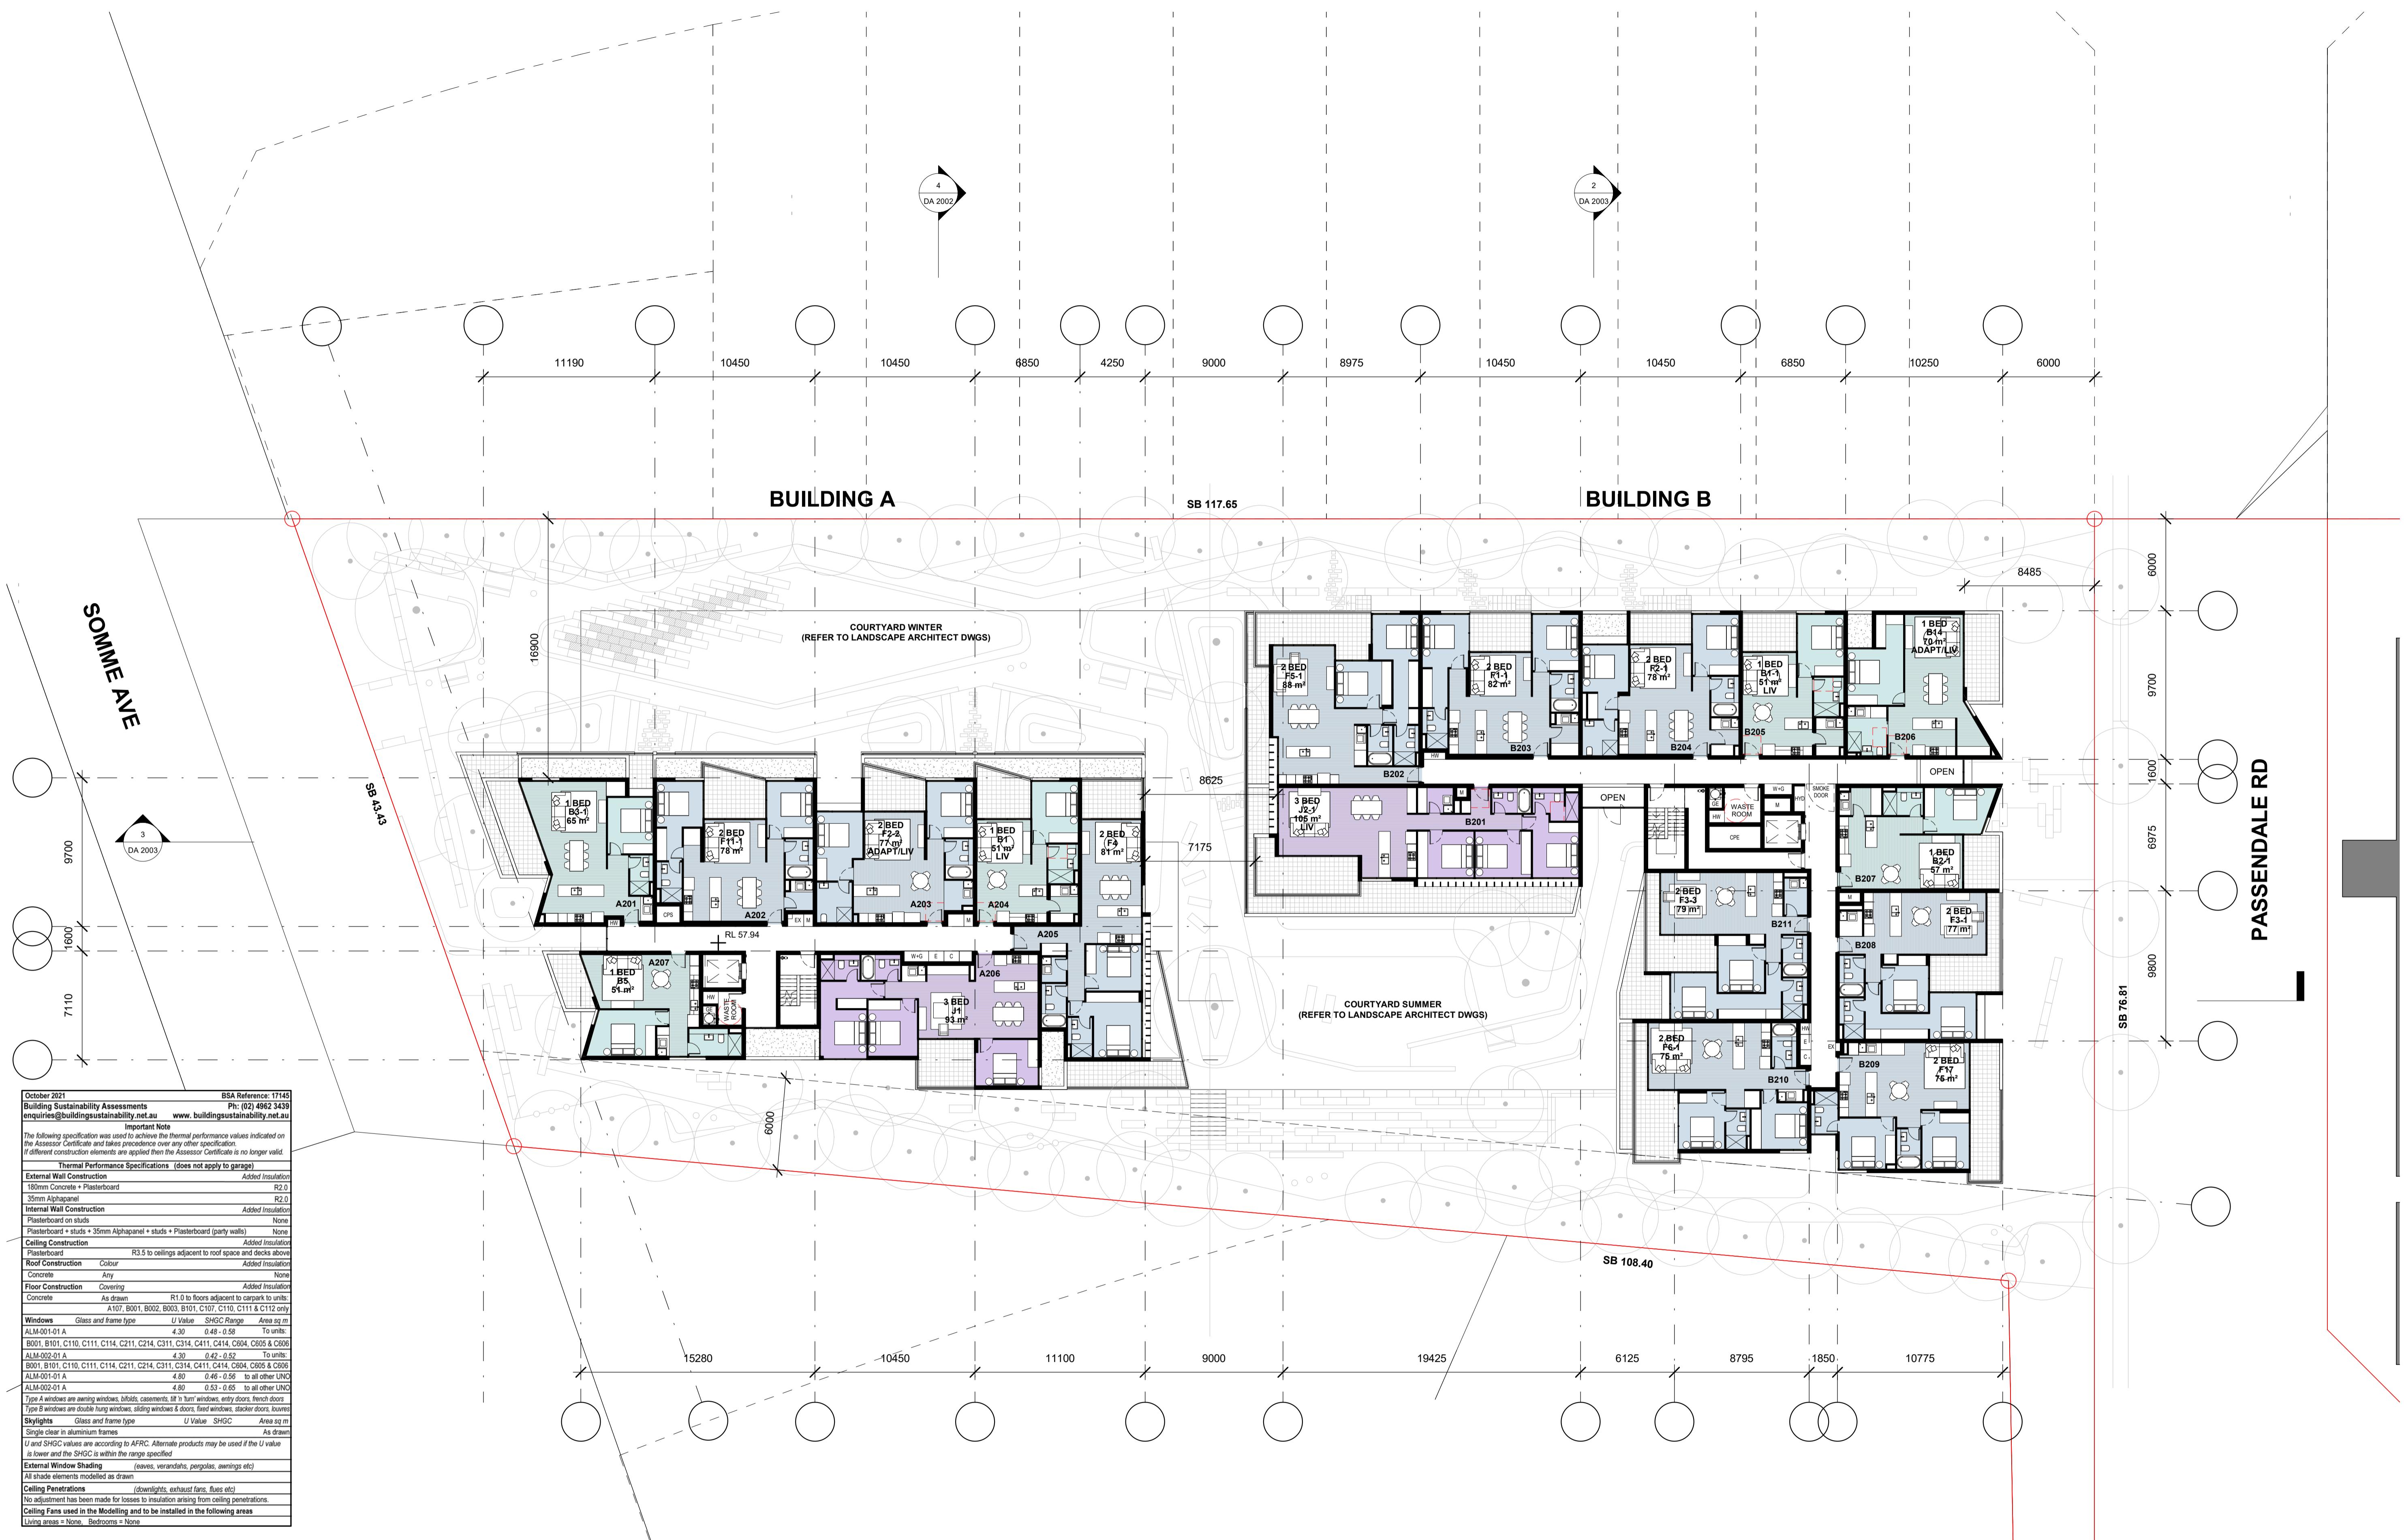
client

CROATIA 88 PTY LTD

project RESIDENTIAL APARTMENT DEVELOPMENT
LOT 3 DP1259121 SOMME AVENUE + LOT 8 DP1200987 CROATIA AVENUE
EDMONDSON PARK

checked drawing FS
scale 1:200 @ A1
1:400 @ A3
drawn JN issue
scale bar 0 2 4 6 8 10 m
project no 20 117 drawing no
DA 1002





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project


RESIDENTIAL APARTMENT DEVELOPMENT

LOT 3 DP1259121 SOMME AVENUE + LOT 8 DP1200987 CROATIA AVENUE EDMONDSON PARK

LEVEL 2 PLAN - DRAFT

DA 1004

scale 1:200@A1 drawn issue
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LOT 3 DP1259121 SOMME AVENUE + LOT 8 DP1200987 CROATIA AVENUE EDMONDSON PARK

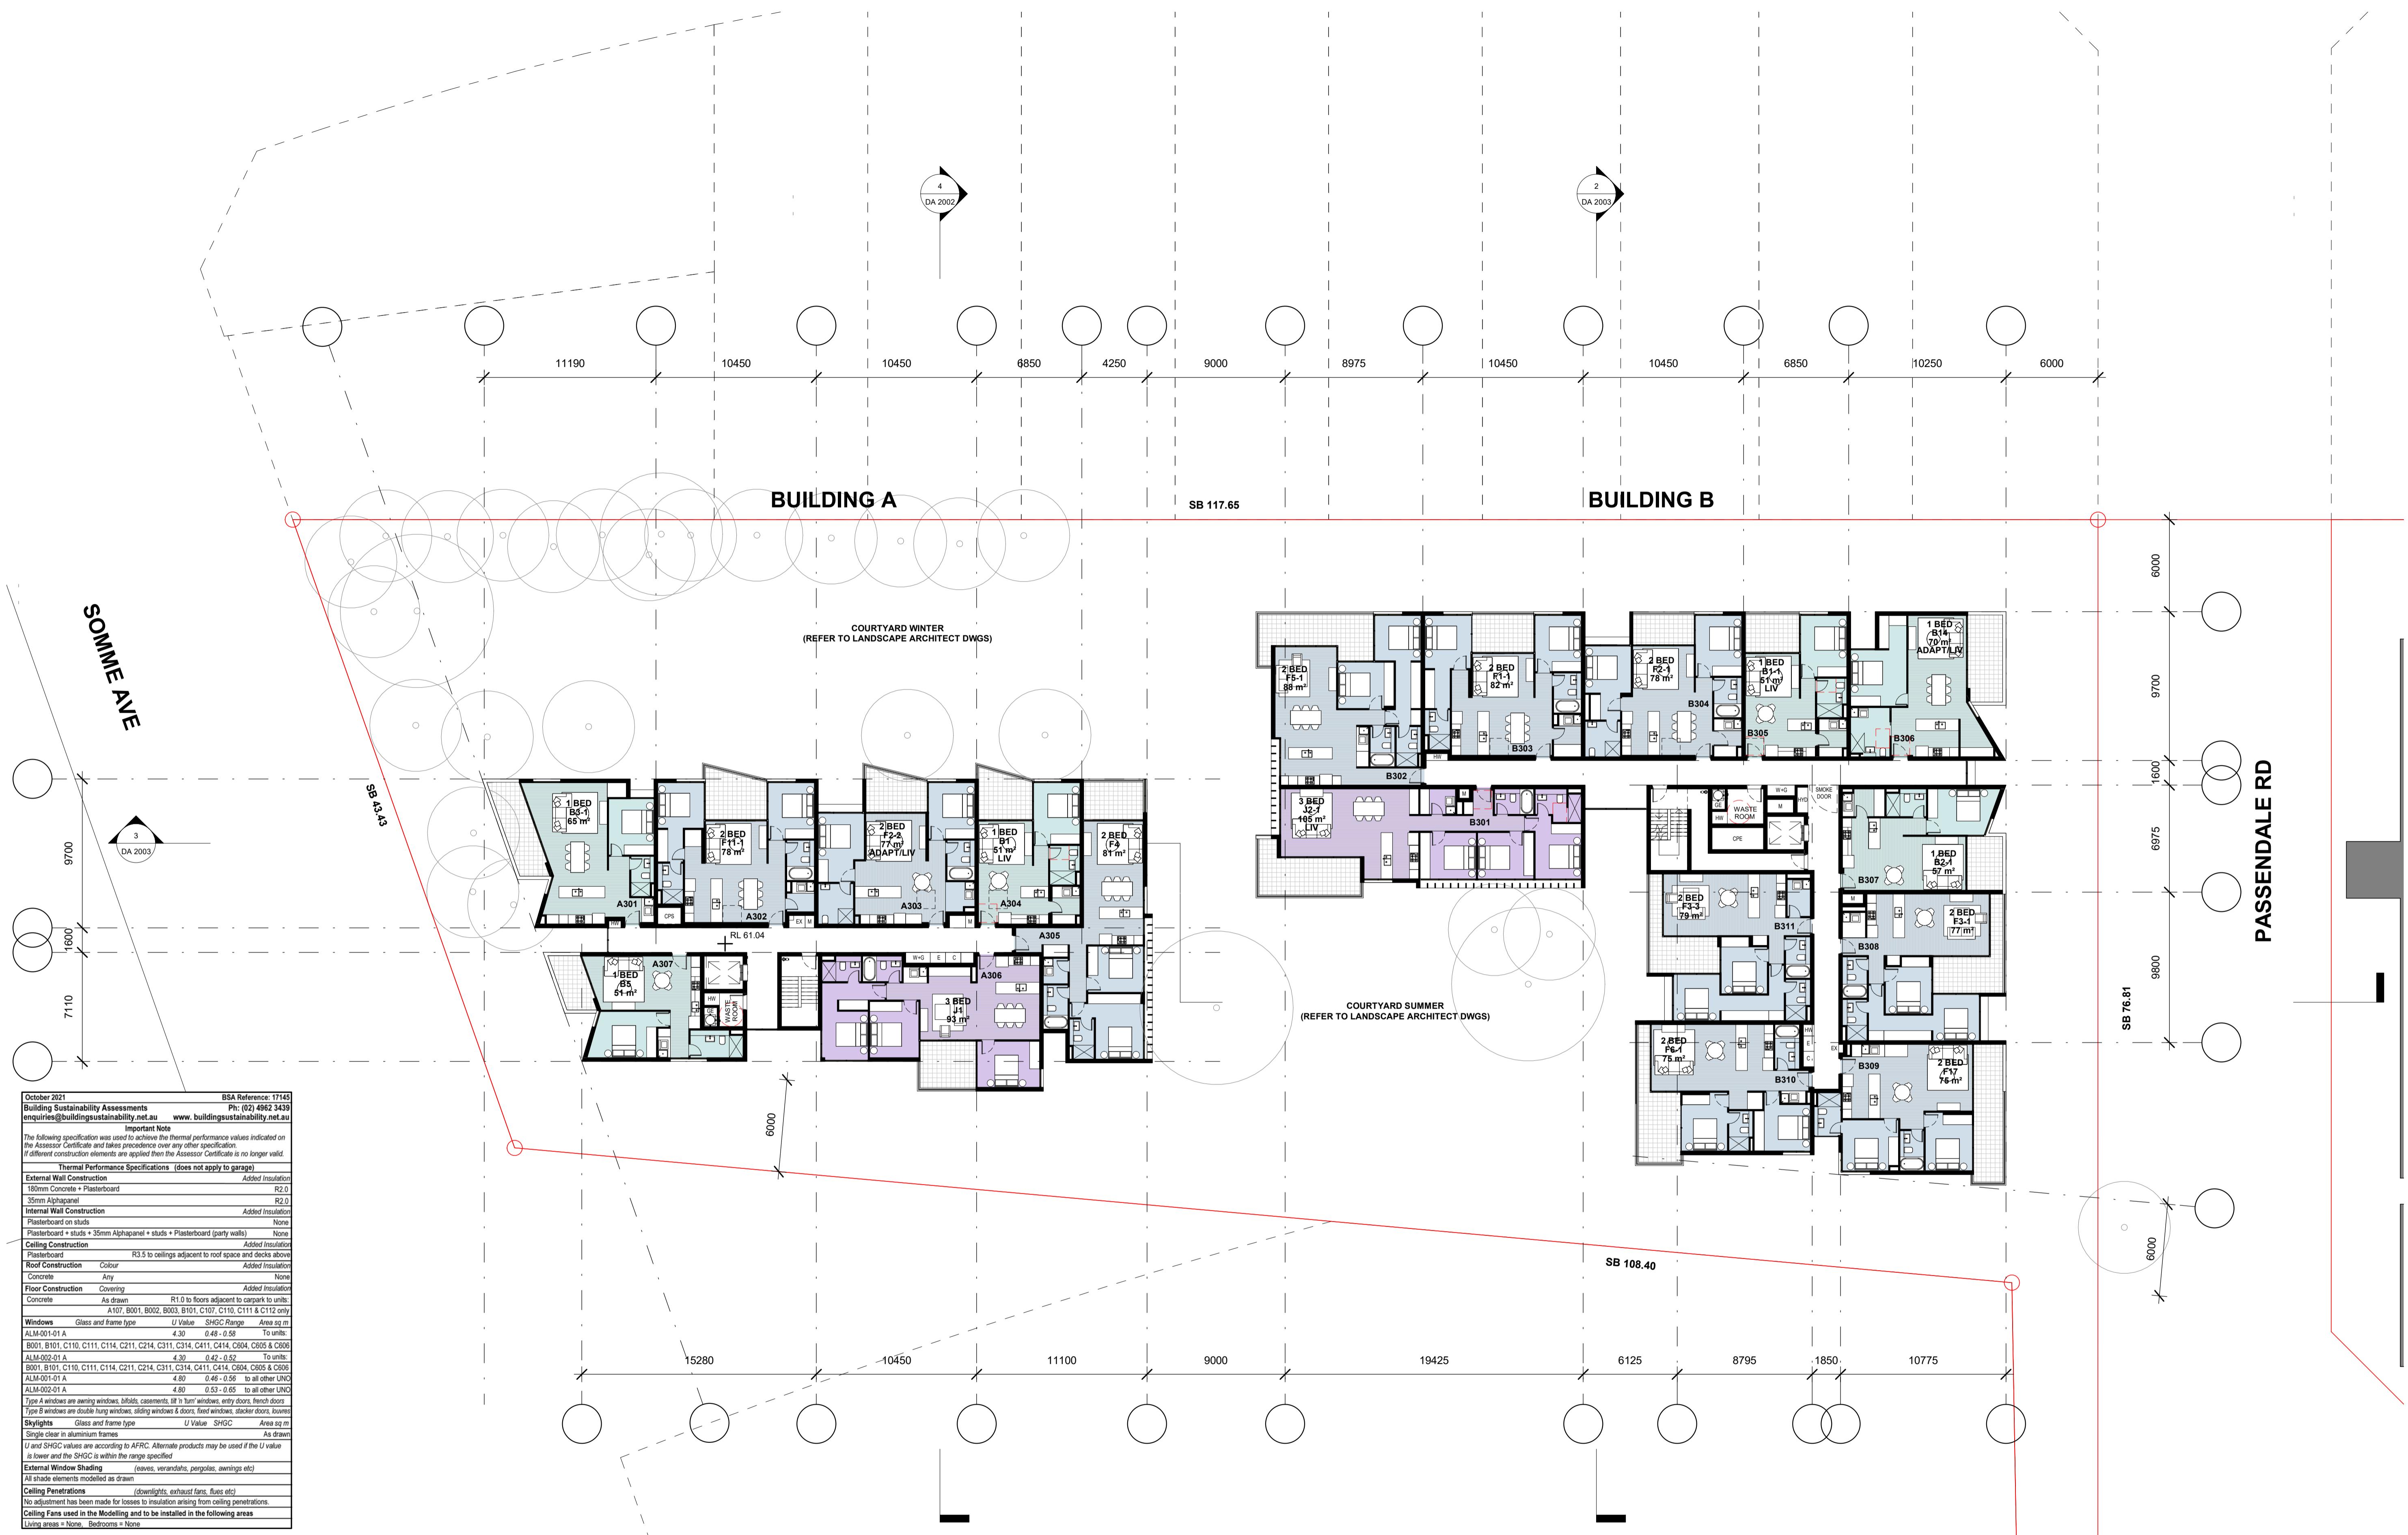Statistic Architects

CROATIA 88 PTY LTD

FS

scale 1:200@A1 drawn issue
1:400@A3 JN

scale bar 0 2 4 6 8 10 project no drawing no
m

20 117 DA 1005

DA 1005



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RESIDENTIAL APARTMENT DEVELOPMENT

LOT 3 DP1259121 SOMME AVENUE + LOT 8 DP1200987 CROATIA AVENUE EDMONDSON PARK

Statistic architects

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checked	drawing	LEVEL 4 PLAN - BLD A+B
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drawn	issue	

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Page 1 of 1

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A ISSUE FOR DEVELOPMENT APPLICATION

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RESIDENTIAL APARTMENT DEVELOPMENT MMF AVENUE • LOT 3 RR1000007 ORGATIA AVENUE

LEVEL 5 PLAN - BLD A+B

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scale		1:200@A1 1:400@A3	drawn	issue				
			Author		A			
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	0	2	4	6	8	10	m	20 117

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client CROATIA 88 PTY LTD scale 1:200 @ A1
1:400 @ A3 drawn JN issue

checked FS drawing

scale bar 0 2 4 6 8 10 m project no 20 117 drawing no

RESIDENTIAL APARTMENT DEVELOPMENT
LOT 3 DP1259121 SOMME AVENUE + LOT 8 DP1200987 CROATIA AVENUE
EDMONDSON PARK
BASEMENT 4 PLAN - BLD C

A

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DA 1101



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LOT 3 DP1259121 SOMME AVENUE + LOT 8 DP1200987 CROATIA AVENUE
EDMONDSON PARK BASEMENT 3 PLAN - BLD C

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NSW ARB Frank Stanisic 4480

client CROATIA 88 PTY LTD

scale 1:200@A1
1:400@A3

checked drawing FS

scale bar 0 2 4 6 8 10 m

drawn JN issue

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project no 20 117 drawing no DA 1102



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03.10.21

Legend

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10 of 10

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RESIDENTIAL APARTMENT DEVELOPMENT AVENUE 11 LOT 2 DP16202027 CROATIA AVENUE

0987 CROATIA AVENUE
EDMONDSON PARK

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RESIDE
3 DP1259121 SOMME AVENU

ARTMENT DEVELOPMENT
DP1200987 CROATIA AVENUE
EDMONDSON PARK

client

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DA 1103



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 A ISSUE FOR DEVELOPMENT APPLICATION 03.10.21 stanisic architects RESIDENTIAL APARTMENT DEVELOPMENT
 03-Nov-21 5:21:53 PM client
 stanisic architects Level 10, 257 Clarence Street, Sydney NSW 2000
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 NSW ARB Frank Stanisic 4480
 project no
 checked drawing FS
 BASEMENT 1 PLAN - BLD C
 drawing no
 JN issue
 1:200 @ A1
 1:400 @ A3
 scale bar 0 2 4 6 8 10 m
 20 117 drawing no
 DA 1104

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03.10.21

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Page 1

RESIDENTIAL APARTMENT DEVELOPMENT

RESIDENTIAL APARTMENT DEVELOPMENT
ME AVENUE - LOT 6 RR1000007 GRC ATIA AVENUE

0987 CROATIA AVENUE
EDMONDSON PARK

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Page 1

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DA 1105



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A ISSUE FOR DEVELOPMENT APPLICATION 03.10.21 RESIDENTIAL APARTMENT DEVELOPMENT
architect stanisic architects
client CROATIA 88 PTY LTD
scale 1:200 @ A1 1:400 @ A3
scale bar 0 2 4 6 8 10 m
checked drawing
FS
JN issue
project no 20 117 drawing no
03-Nov-21 4:54 PM
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DA 1106



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client CROATIA 88 PTY LTD scale 1:200 @ A1
 drawing 1:400 @ A3
 checked FS
 drawing JN issue
 scale bar 0 2 4 6 8 10 m project no 20 117 drawing no DA 1107

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 A ISSUE FOR DEVELOPMENT APPLICATION 03.10.21 stanisic architects Level 10, 257 Clarence Street, Sydney NSW 2000
 client CROATIA 88 PTY LTD scale 1:200 @ A1
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 03-Nov-21 10:14 PM
 RESIDENTIAL APARTMENT DEVELOPMENT
 LOT 3 DP1259121 SOMME AVENUE + LOT 8 DP1200987 CROATIA AVENUE
 EDMONDSON PARK
 LEVEL 4 PLAN - BLD C
 DA 1108



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RESIDENTIAL APARTMENT DEVELOPMENT

RESIDENTIAL APARTMENT DEVELOPMENT
5 AVENUE - LOT 2 DP1600007 CROATIA AVENUE


CROATIA AVENUE MONDSON PARK

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project no drawing no
20 117 DA 1109

DA 1109



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 NSW ARB Frank Stanisic 4480

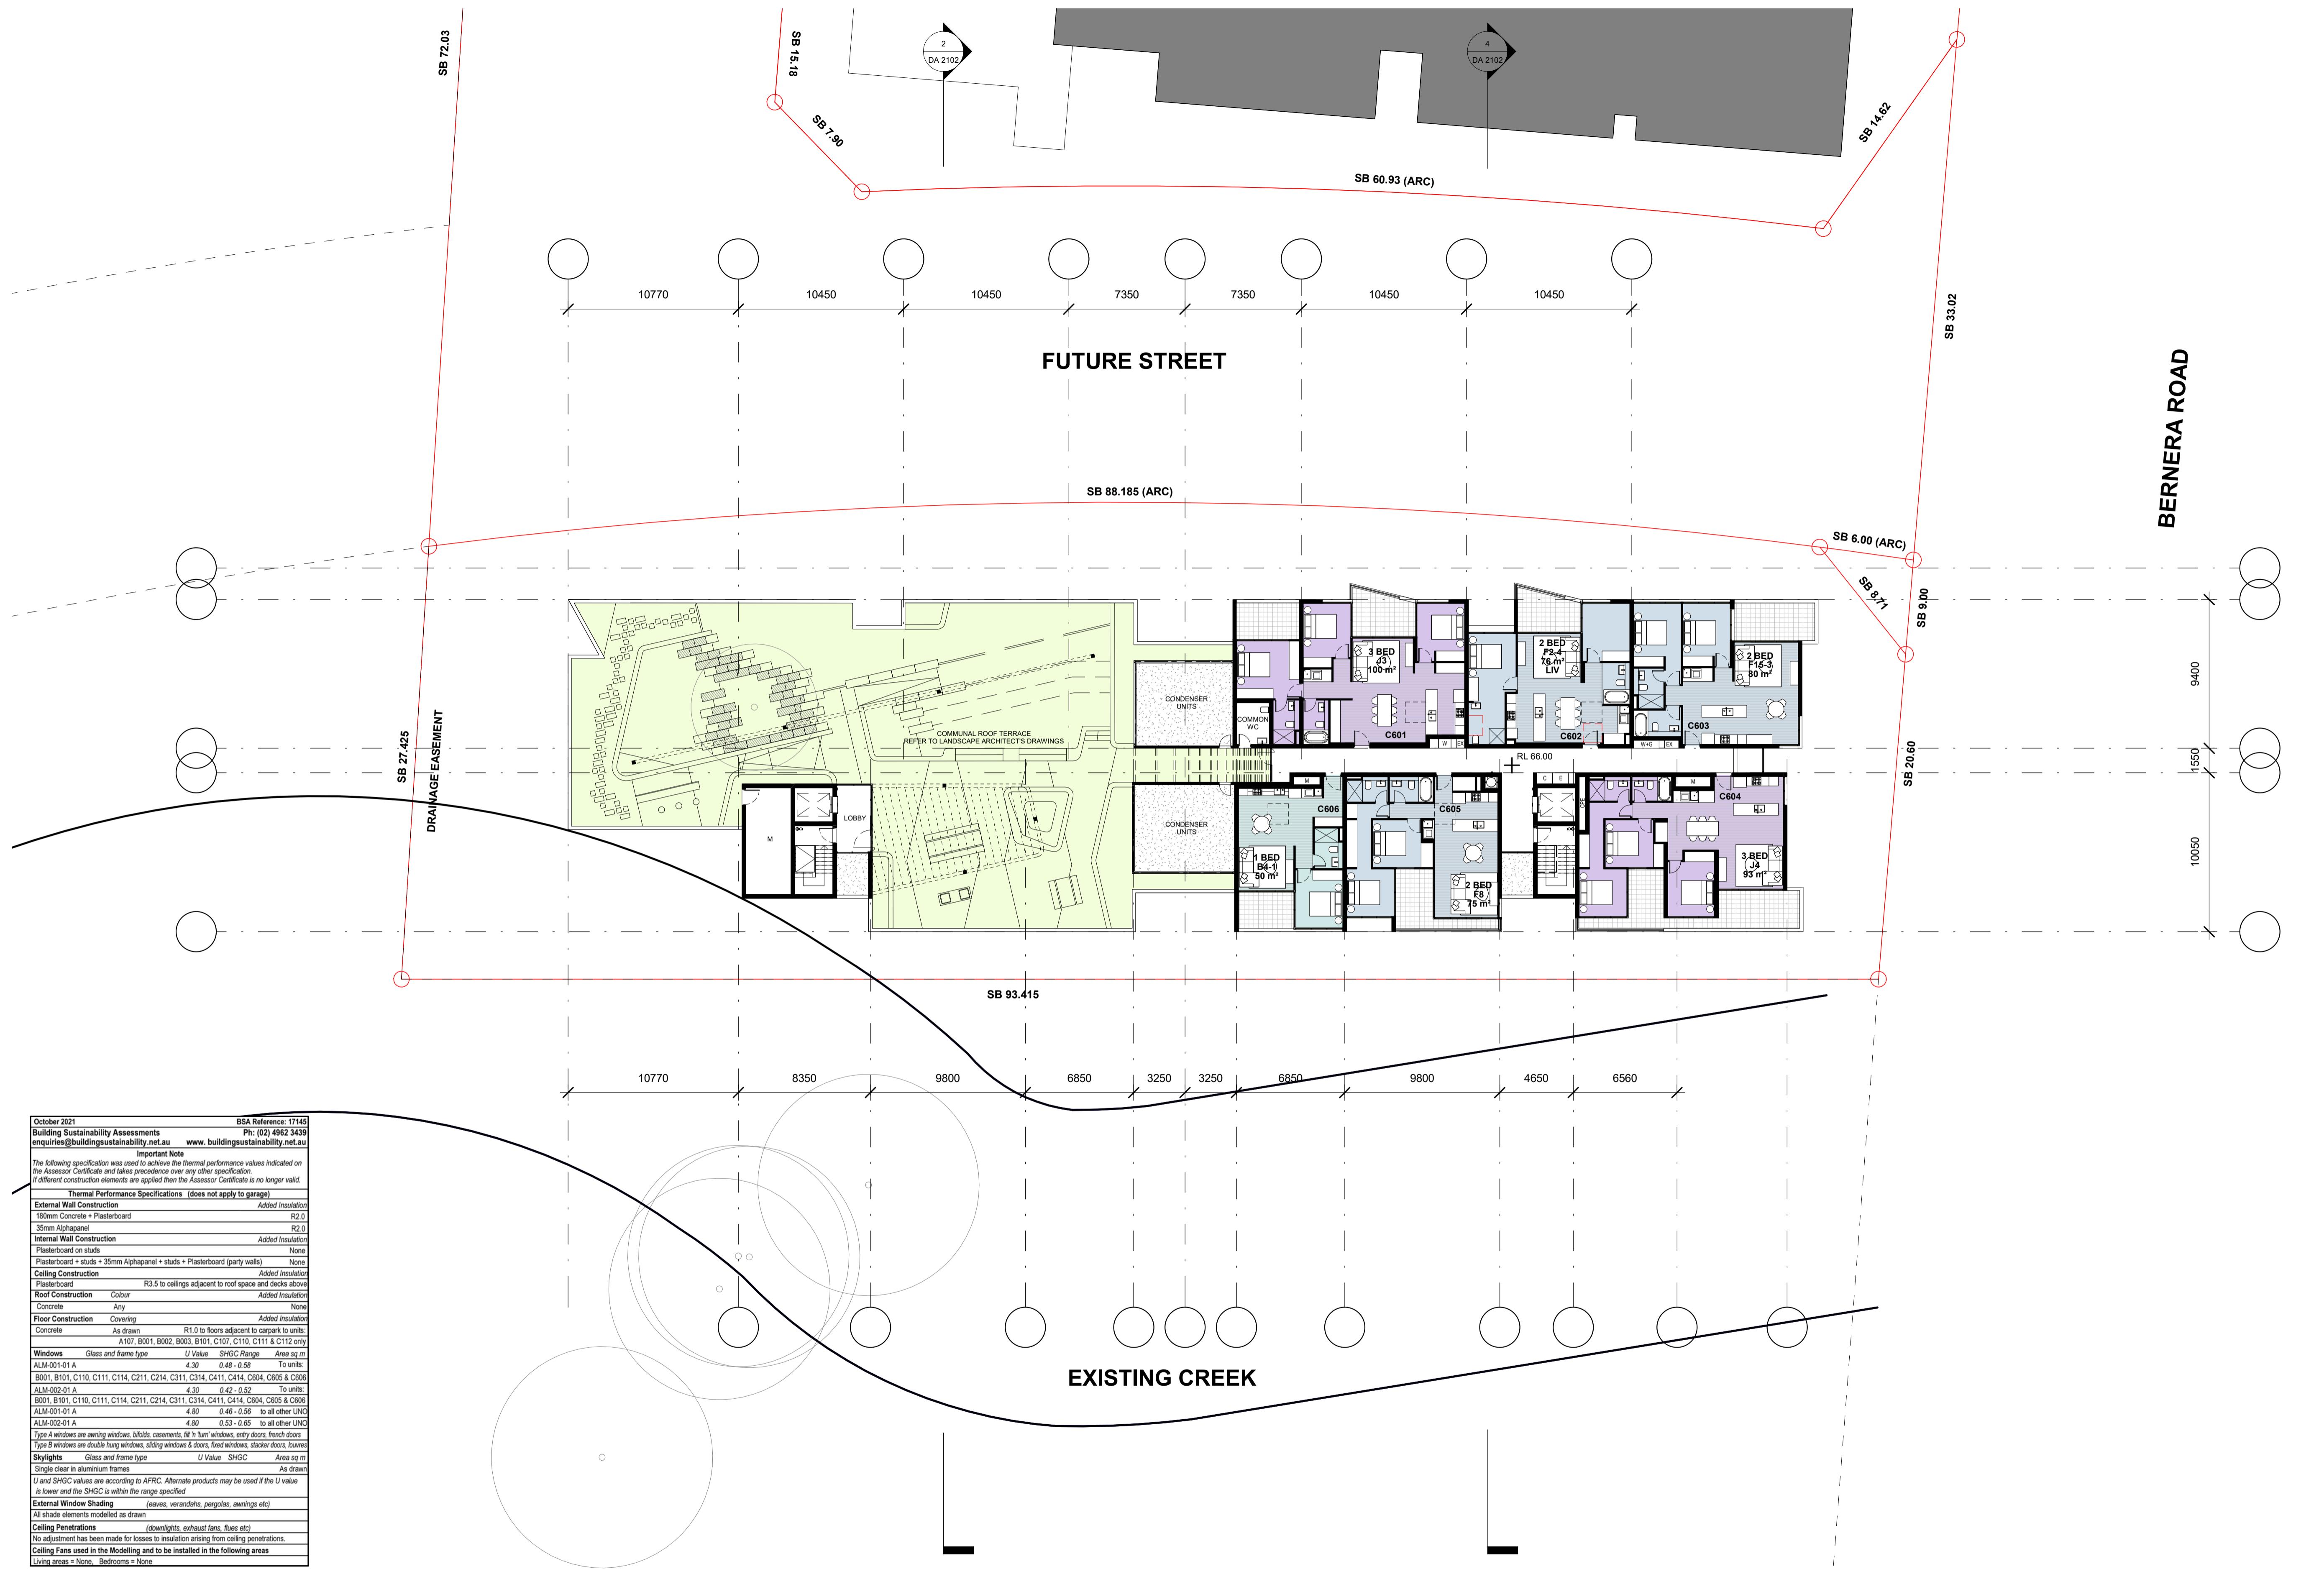client CROATIA 88 PTY LTD

project RESIDENTIAL APARTMENT DEVELOPMENT
 LOT 3 DP1259121 SOMME AVENUE + LOT 8 DP1200987 CROATIA AVENUE
 EDMONDSON PARK


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scale bar 0 2 4 6 8 10 m

checked FS drawing
 drawn JN issue
 project no 20 117 drawing no

do not scale from drawings.
 the layout shown and the areas noted on this drawing are indicative only. layouts are to be read in conjunction with floor plans, elevations & sections.

03-Nov-21 4:01:33 PM DA 1110

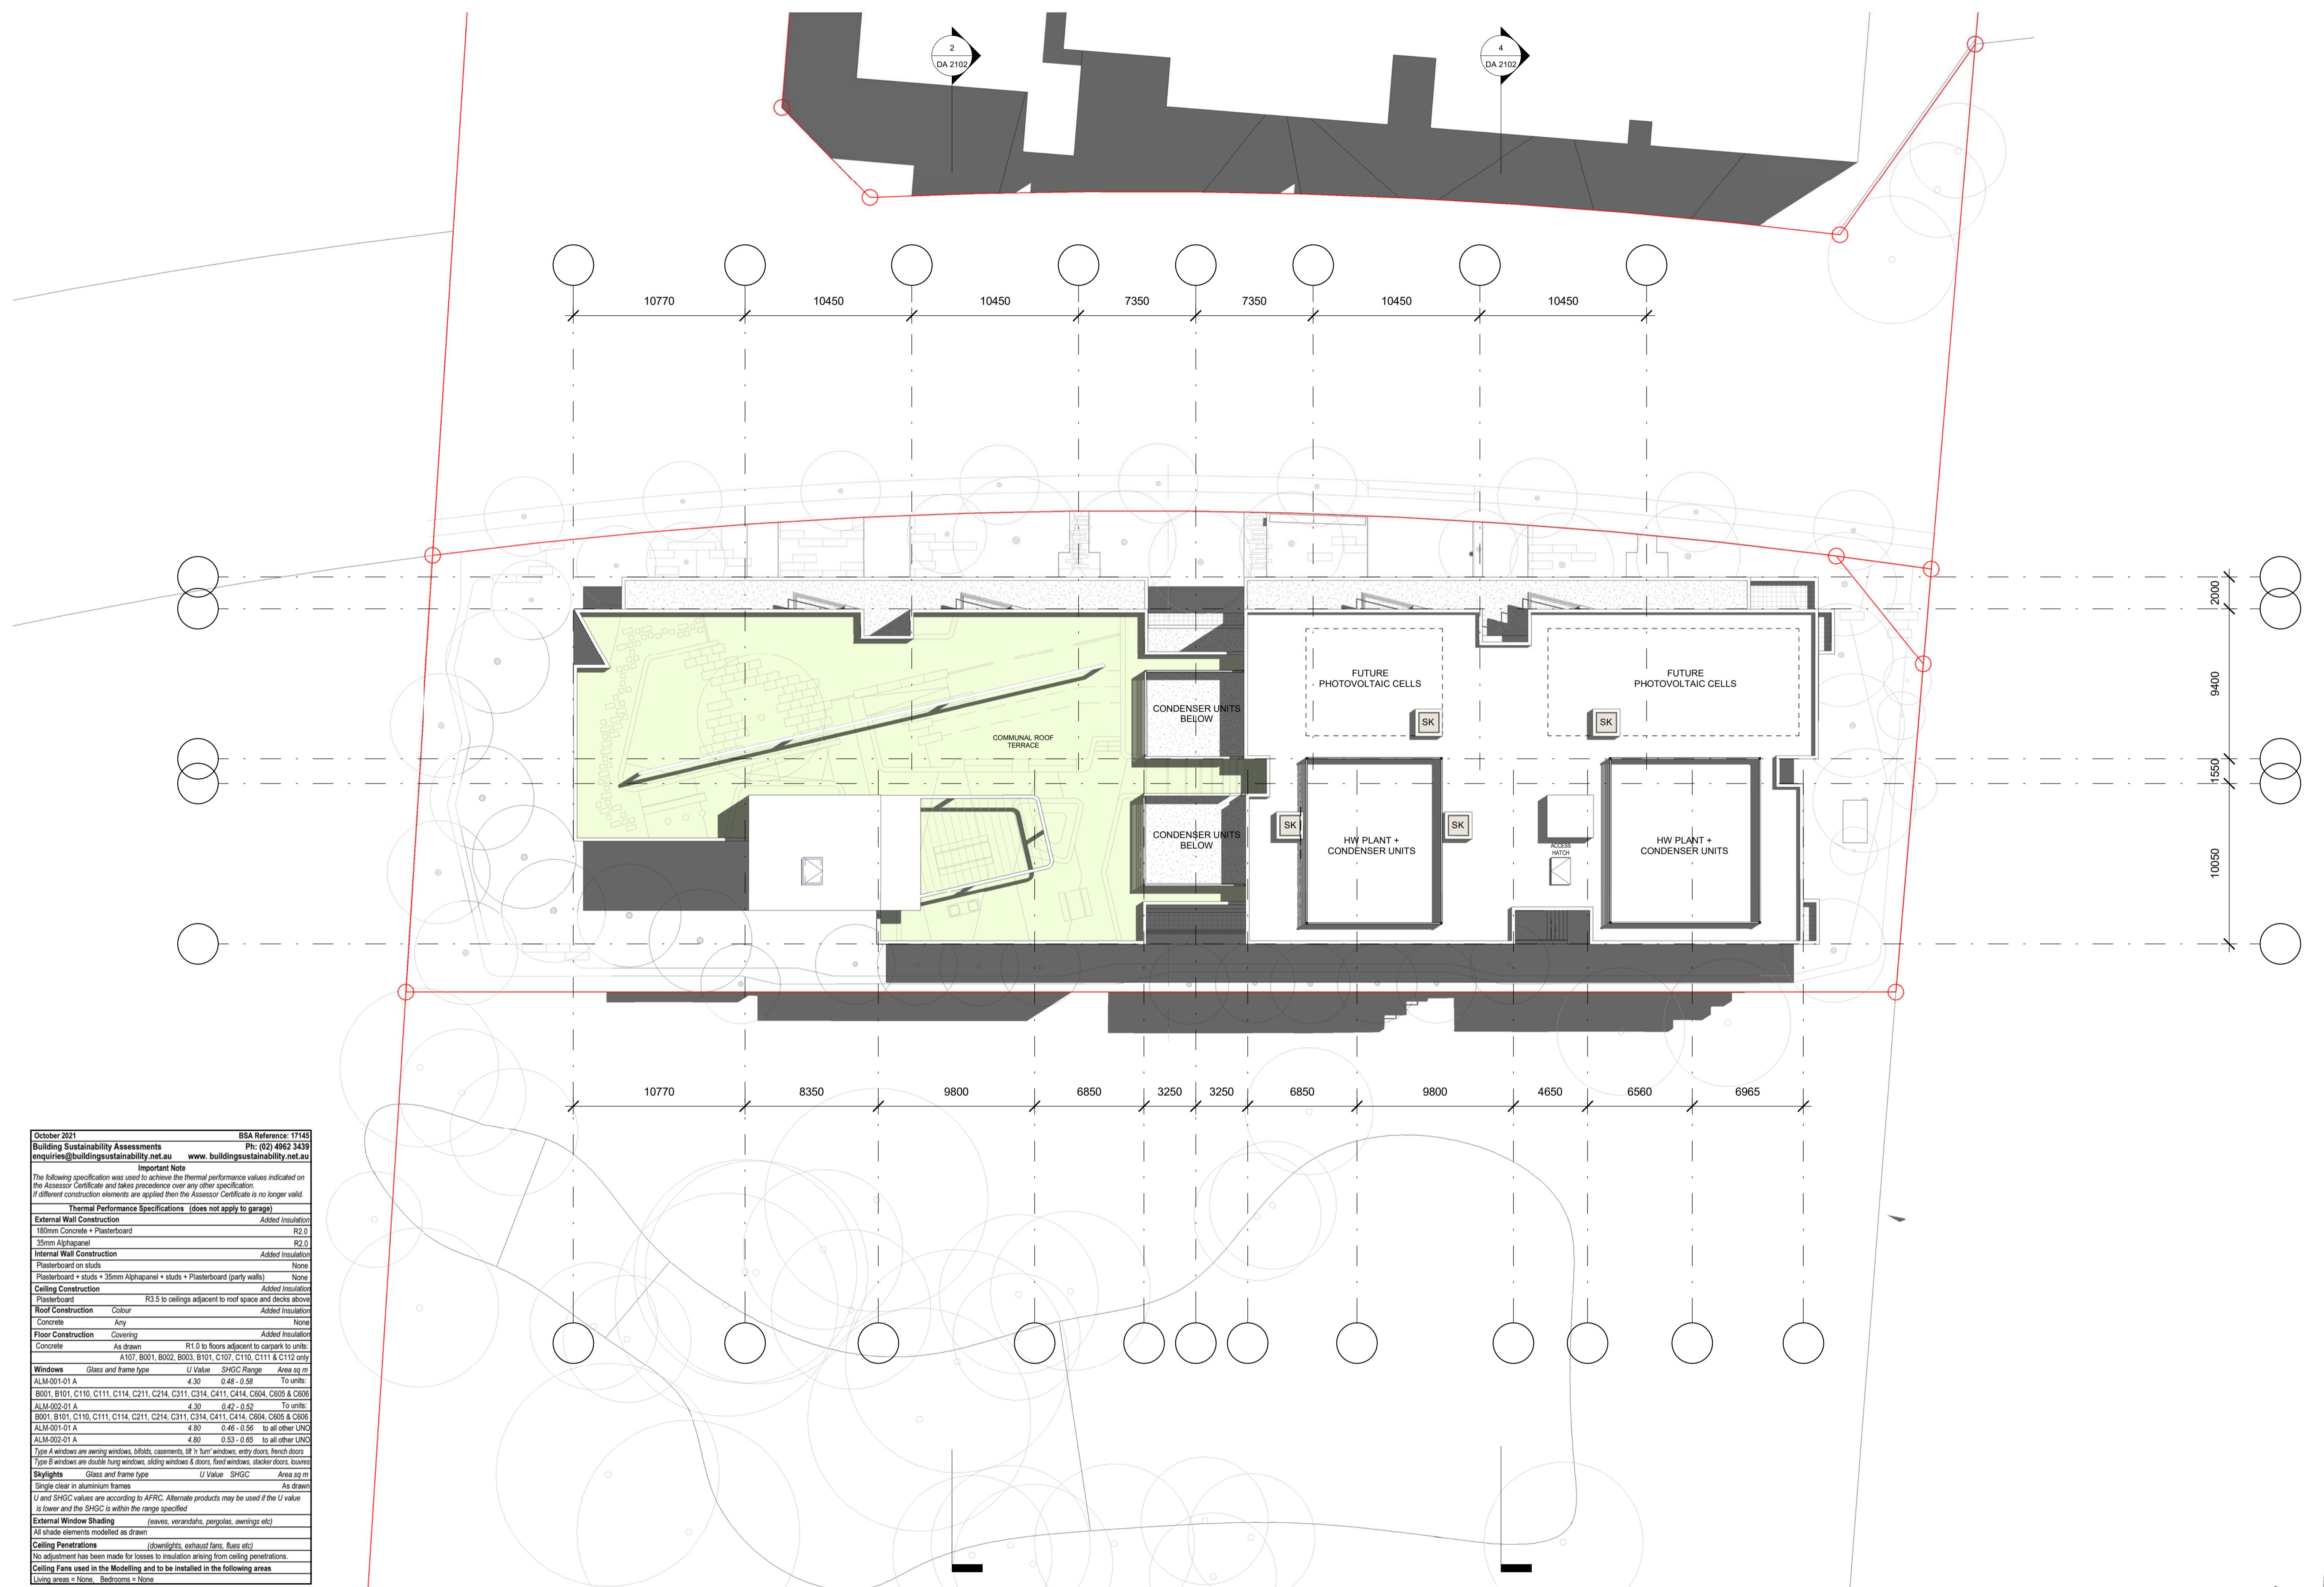

issue amendment date legend architect project
 A ISSUE FOR DEVELOPMENT APPLICATION 03.10.21 stanisic architects RESIDENTIAL APARTMENT DEVELOPMENT
 03-Nov-21 4:01:48 PM


client project
 CROATIA 88 PTY LTD LOT 3 DP1259121 SOMME AVENUE + LOT 8 DP1200987 CROATIA AVENUE
 EDMONDSON PARK ROOF PLAN - BLD C

scale checked drawing
 1:200 @ A1 FS
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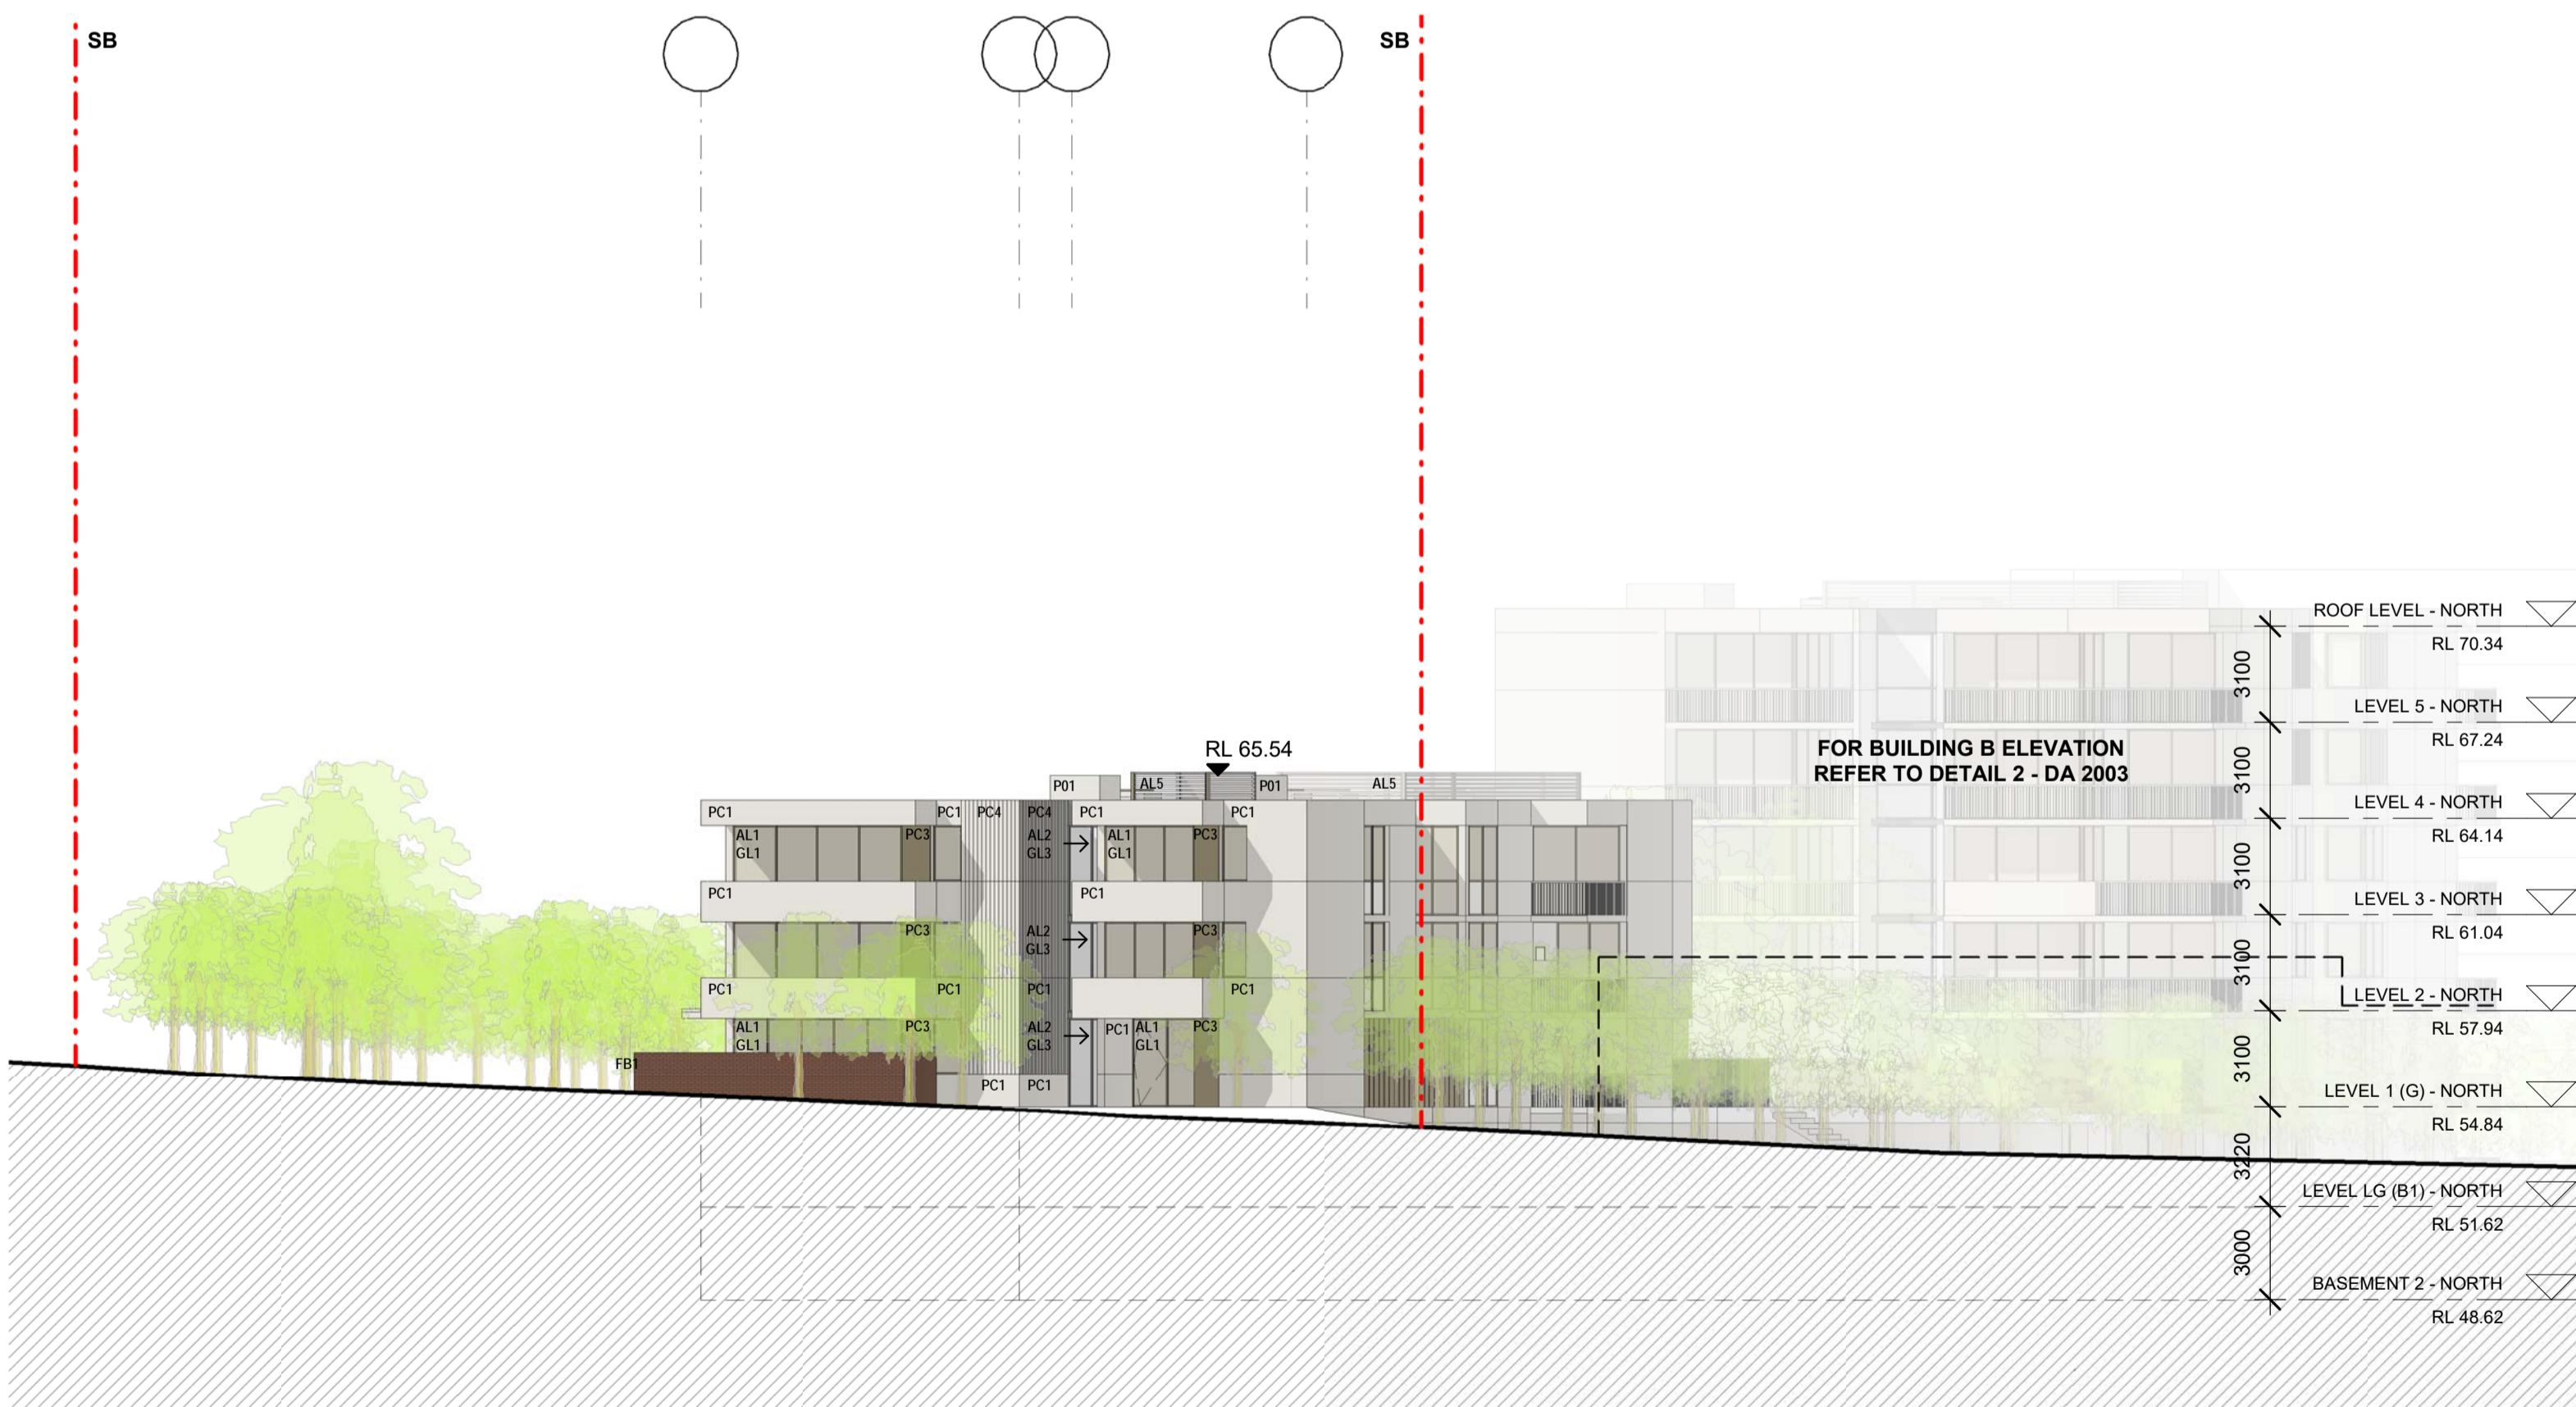
DA 1111



issue	amendment	date	legend	architect	project
A	ISSUE FOR DEVELOPMENT APPLICATION	03.10.21	AL1 ALUMINIUM FRAMED WINDOWS + DOORS, DULUX, ELECTRO RANGE, DARK BRONZE AL2 ALUMINIUM FRAMED WINDOWS + DOORS, DULUX, ELECTRO RANGE, LIGHT BRONZE AL3 ALUMINIUM BATTENS, DULUX, ELECTRO RANGE, MEDIUM BRONZE AL4 ALUMINIUM PLANT SCREEN, DULUX, ELECTRO RANGE, MEDIUM BRONZE AL5 ALUMINIUM PICKET BALUSTRADE, DULUX ELECTRO RANGE, MEDIUM BRONZE FB1 FACEBRICK, DRY PRESENT, BOWRAL BLUE GL1 CLEAR GLASS, VIRIDIAN, BRONZE GL2 TRANSLUCENT GLASS, VIRIDIAN, LUMINA CLOUD, DARK GREY GL3 TRANSLUCENT GLASS, VIRIDIAN, LUMINA CLOUD, BRONZE GL4 TRANSLUCENT GLASS, VIRIDIAN, LUMINA CLOUD, GREY	stanisic architects Level 10, 257 Clarence Street, Sydney NSW 2000 T: (02) 9358 2588 stanisic.com.au ABN 11002633481 NSW ARB Frank Stanisic 4480	RESIDENTIAL APARTMENT DEVELOPMENT
					LOT 3 DP1259121 SOMME AVENUE + LOT 8 DP1200987 CROATIA AVENUE EDMONDSON PARK
					checked drawing FS
					NORTH + SOUTH ELEVATION (BLD A+B)
					scale 1:200 @ A1 1:400 @ A3
					drawn JN issue
					project no 20 117 drawing no
					DA 2001

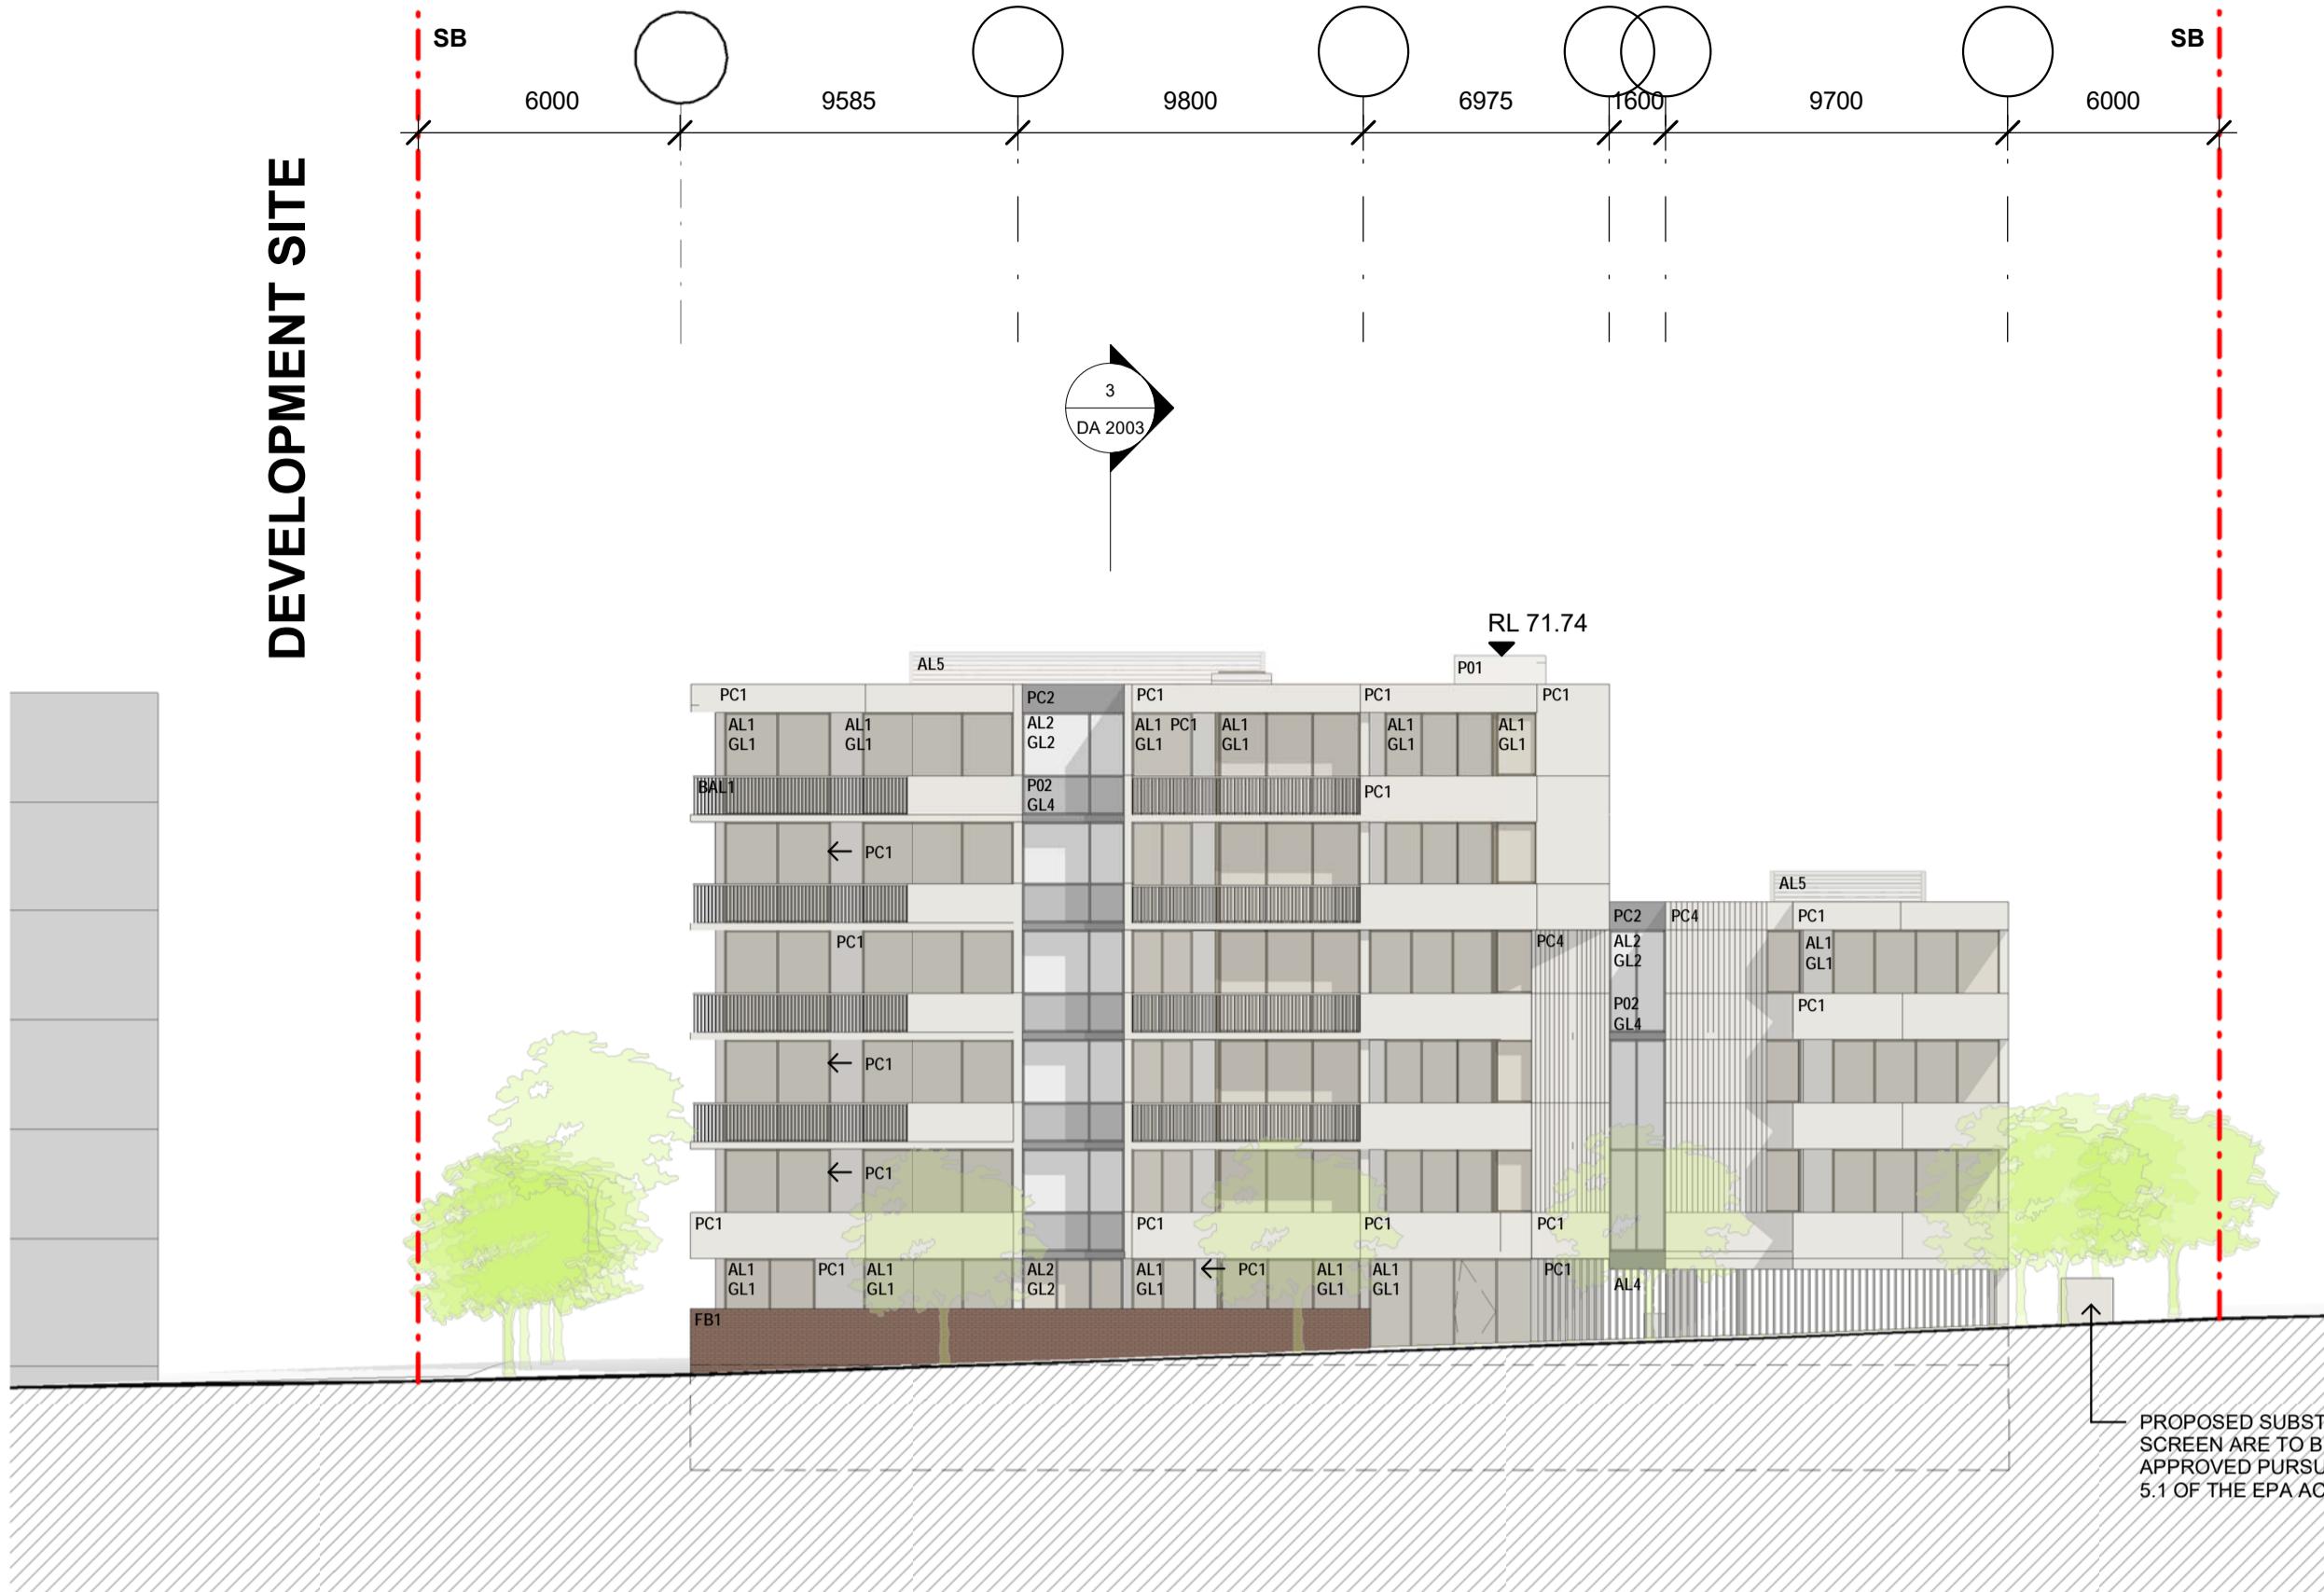


① EAST ELEVATION - PASSENDALE RD (BUILDING B)
1 : 200




② WEST ELEVATION - SOMME AVE (BUILDING A)
1 : 200

issue	amendment	date	legend
A	ISSUE FOR DEVELOPMENT APPLICATION	03.10.21	AL1 ALUMINIUM FRAMED WINDOWS + DOORS, DULUX, ELECTRO RANGE, DARK BRONZE AL2 ALUMINIUM FRAMED WINDOWS + DOORS, DULUX, ELECTRO RANGE, LIGHT BRONZE AL3 ALUMINIUM FRAMED WINDOWS + DOORS, DULUX, ELECTRO RANGE, MEDIUM BRONZE AL4 ALUMINIUM BATTENS, DULUX, ELECTRO RANGE, MEDIUM BRONZE AL5 ALUMINIUM PLANT SCREEN, DULUX, ELECTRO RANGE, MEDIUM BRONZE BAL1 ALUMINIUM PICKET BALUSTRADE, DULUX ELECTRO RANGE, MEDIUM BRONZE FB1 FACEBRICK, DRY PRERESSED, BOWRAL BLUE GL1 CLEAR GLASS, VIRIDIAN, BRONZE GL2 TRANSLUCENT GLASS, VIRIDIAN, LUMINA CLOUD, DARK GREY GL3 TRANSLUCENT GLASS, VIRIDIAN, LUMINA CLOUD, BRONZE GL4 TRANSLUCENT GLASS, VIRIDIAN, LUMINA CLOUD, GREY
			P01 INSITU CONCRETE, PAINT FINISH, COLOUR TO MATCH PC1 P02 INSITU CONCRETE, PAINT FINISH, COLOUR TO MATCH PC2 PC1 MASONRY, PAINT FINISH, MALAY GREY OR SIMILAR PC2 MASONRY, PAINT FINISH, MUD PACK OR SIMILAR PC3 MASONRY, PAINT FINISH, GREY PEBBLE OR SIMILAR PC4 MASONRY, GROOVES, PAINT FINISH, GREY PEBBLE OR SIMILAR
			stanisic architects stanisic architects stanisic architects
			CROATIA 88 PTY LTD

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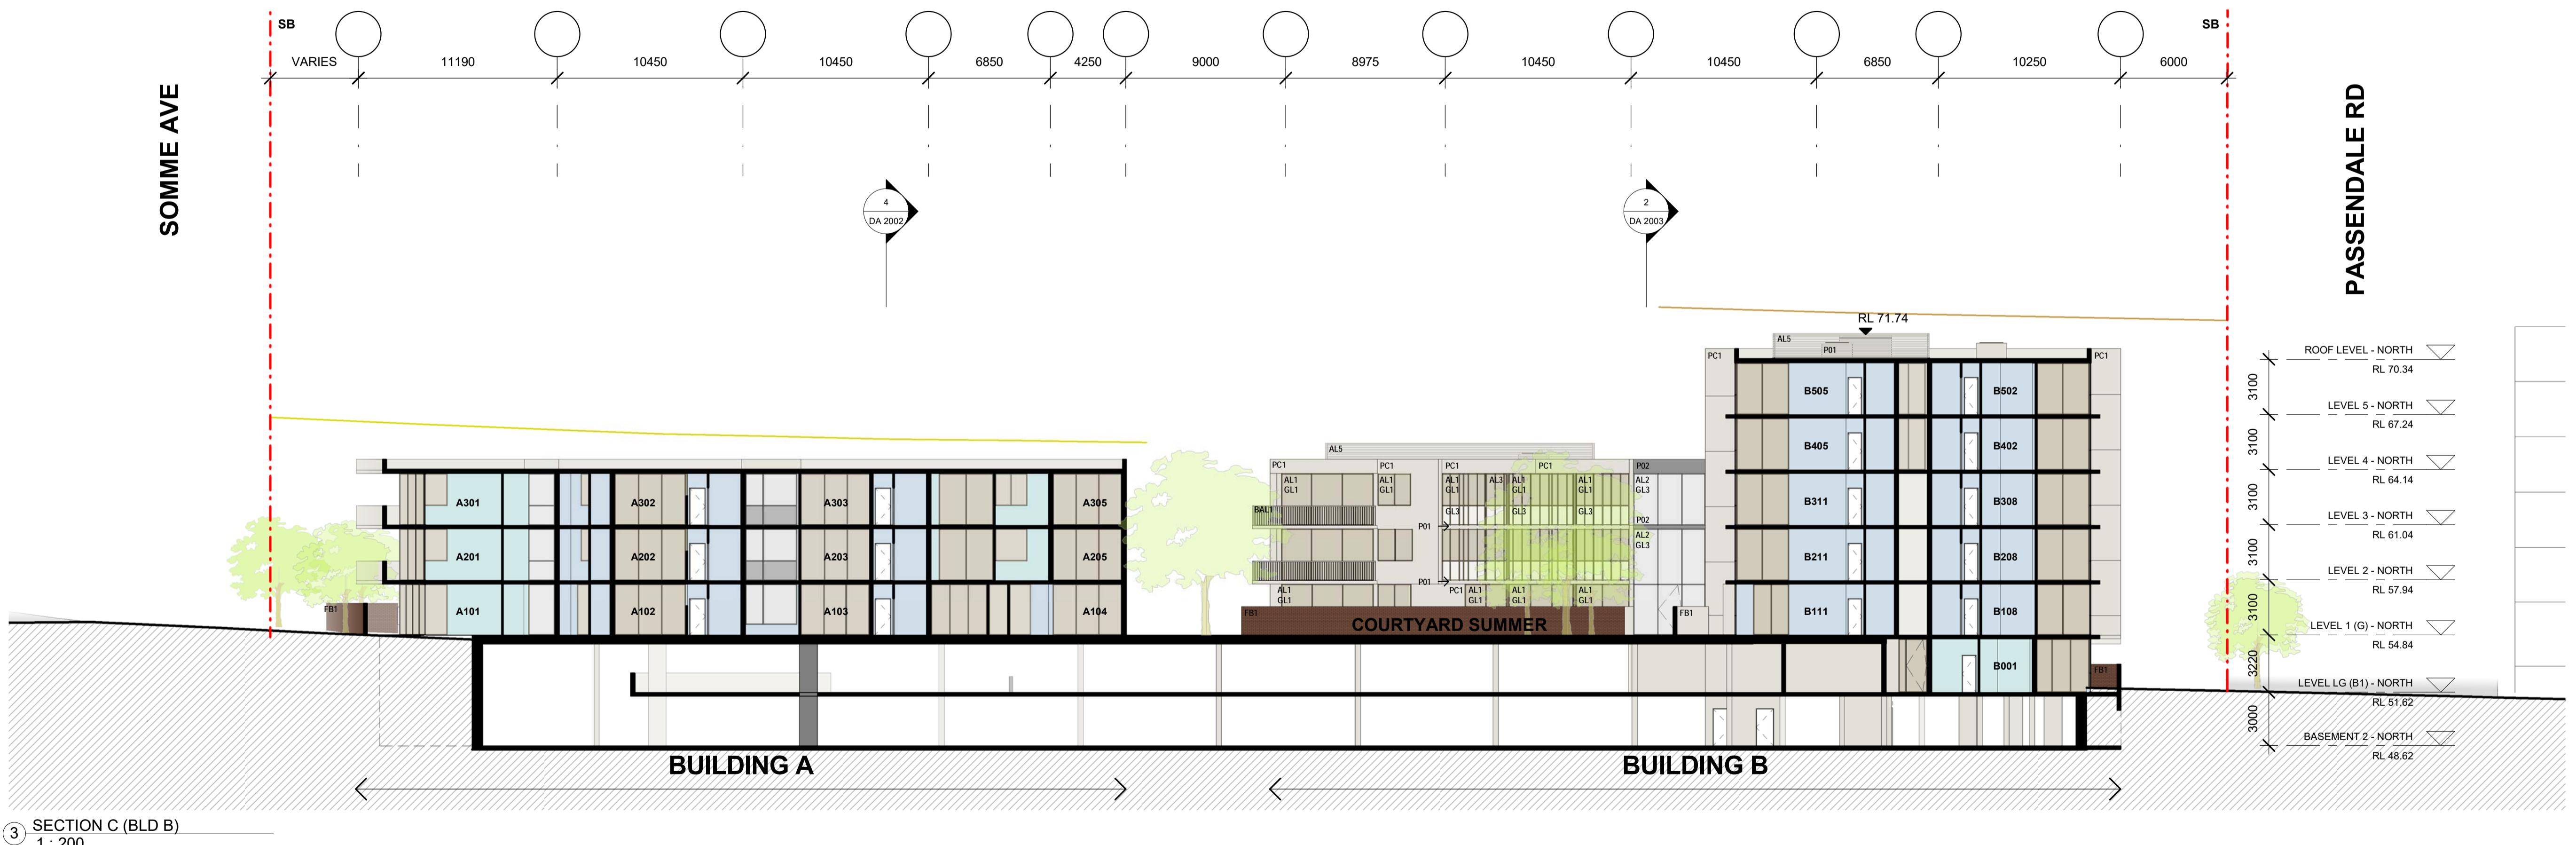
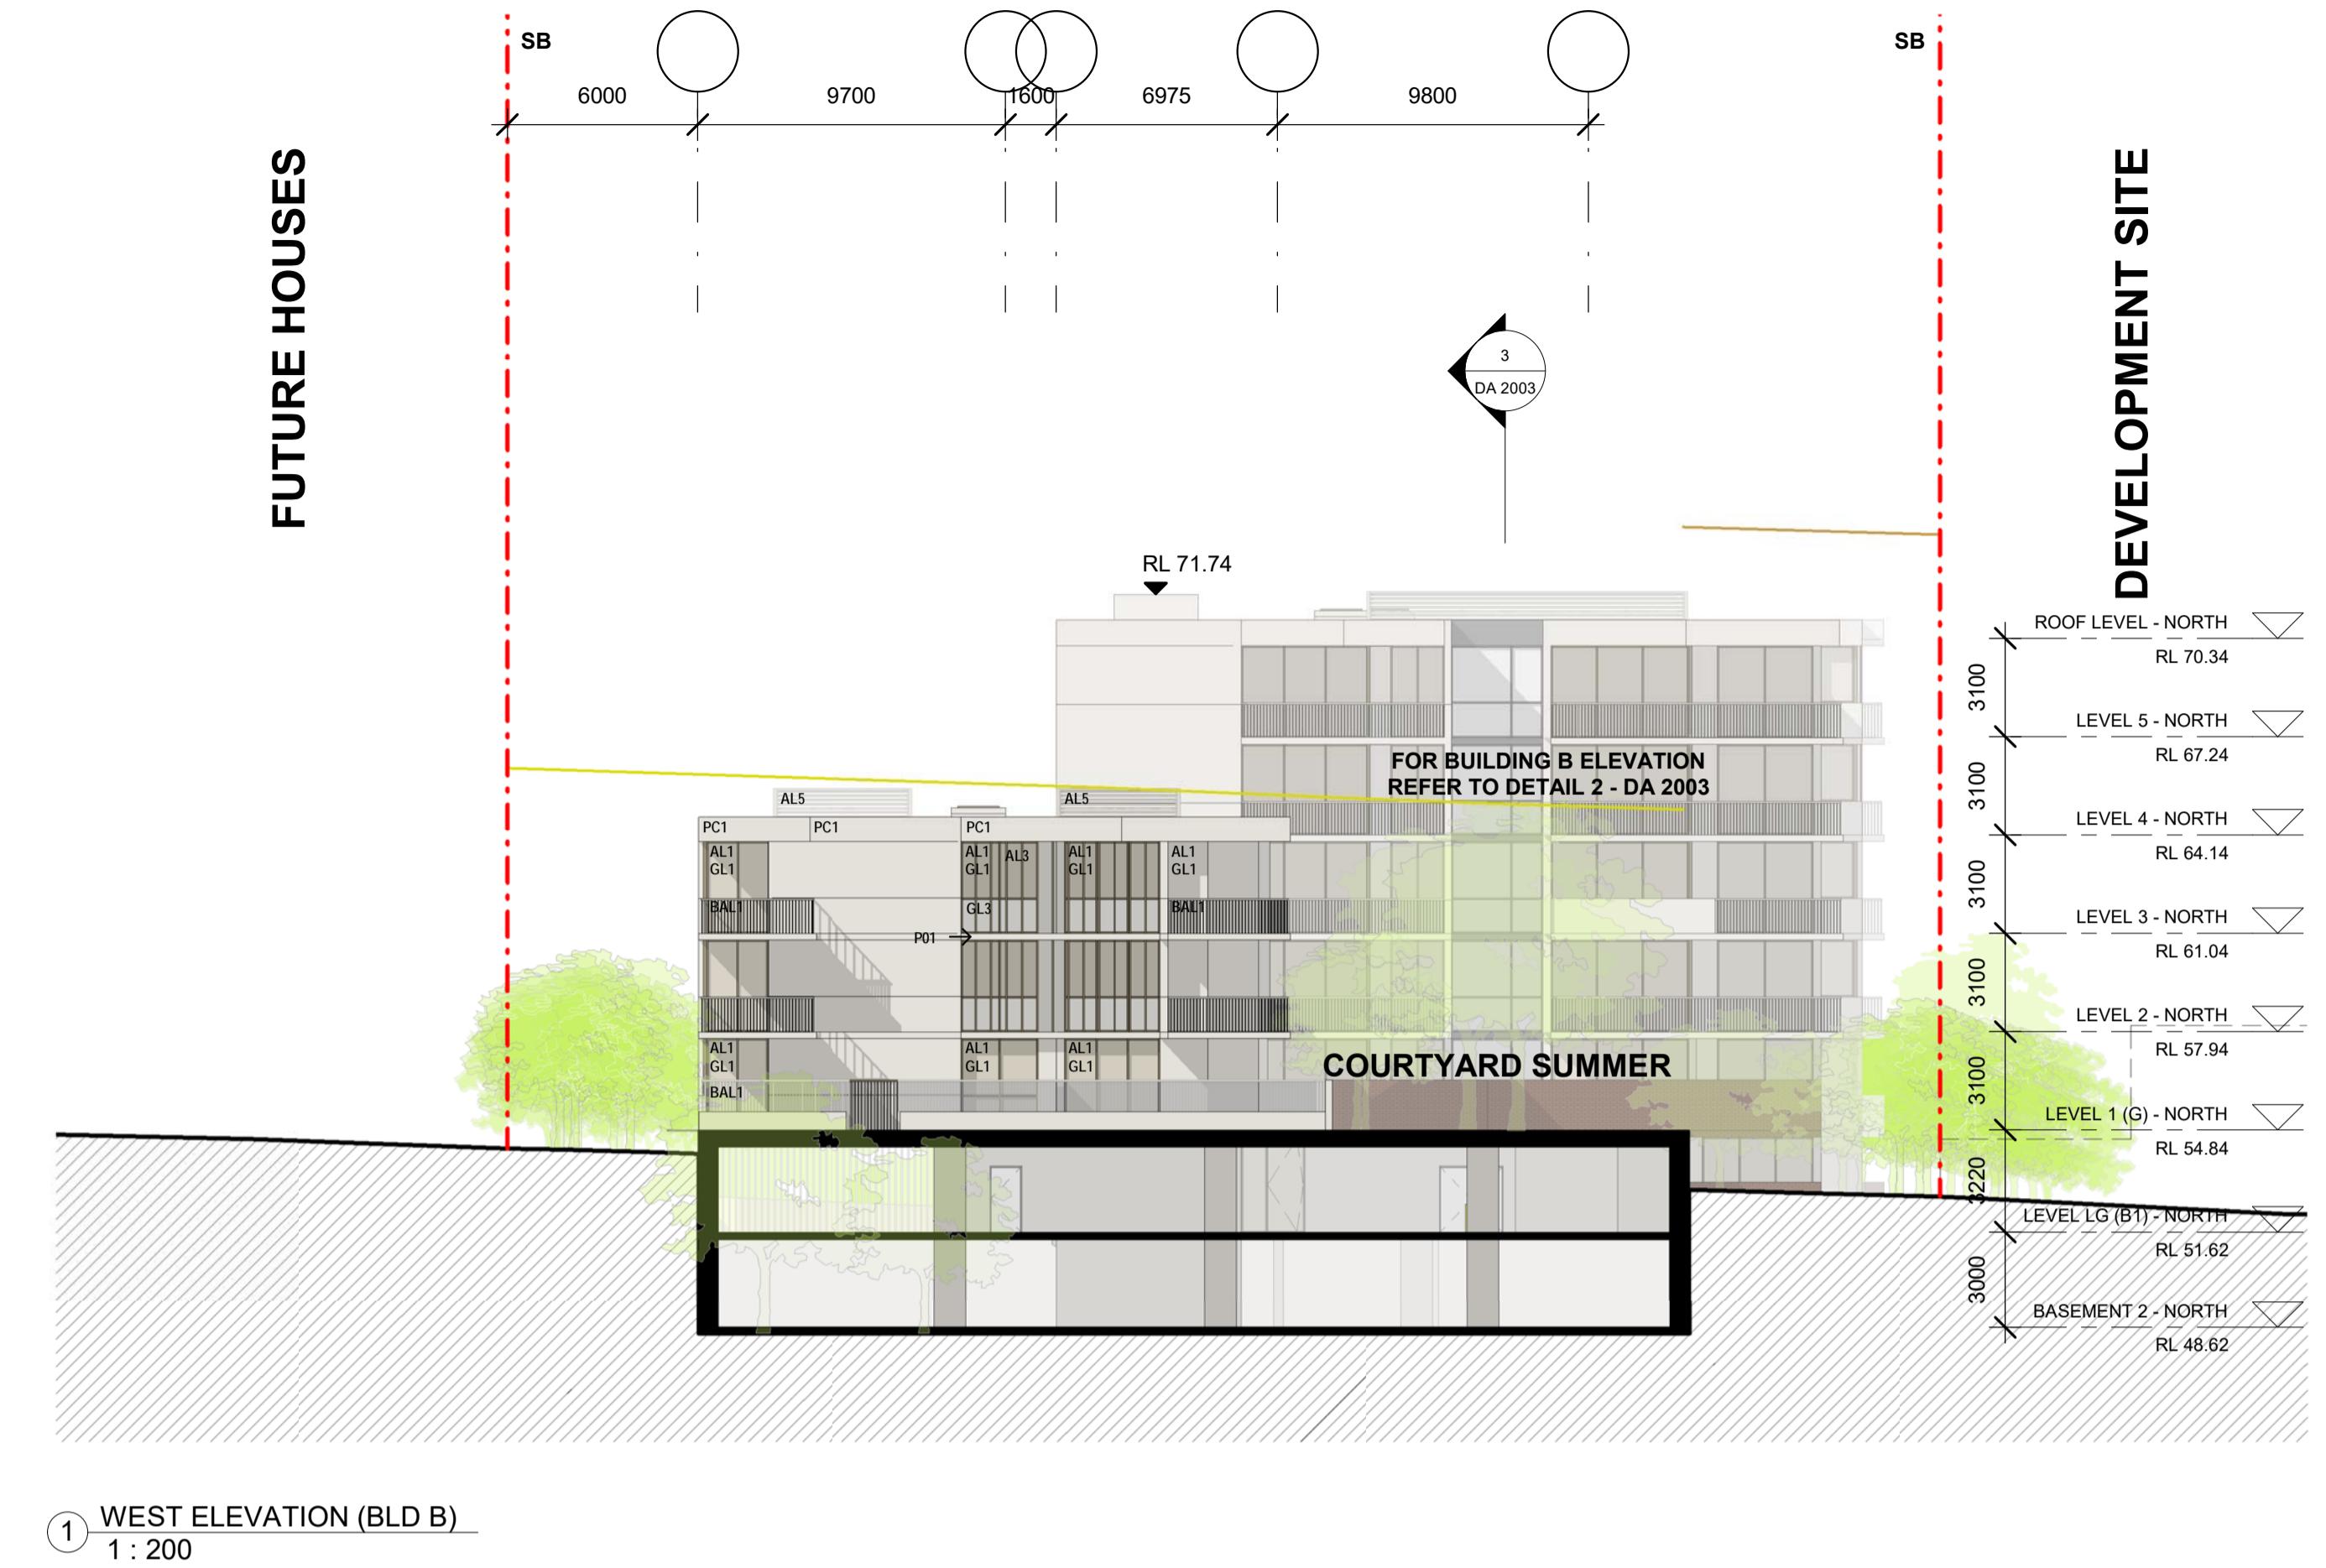
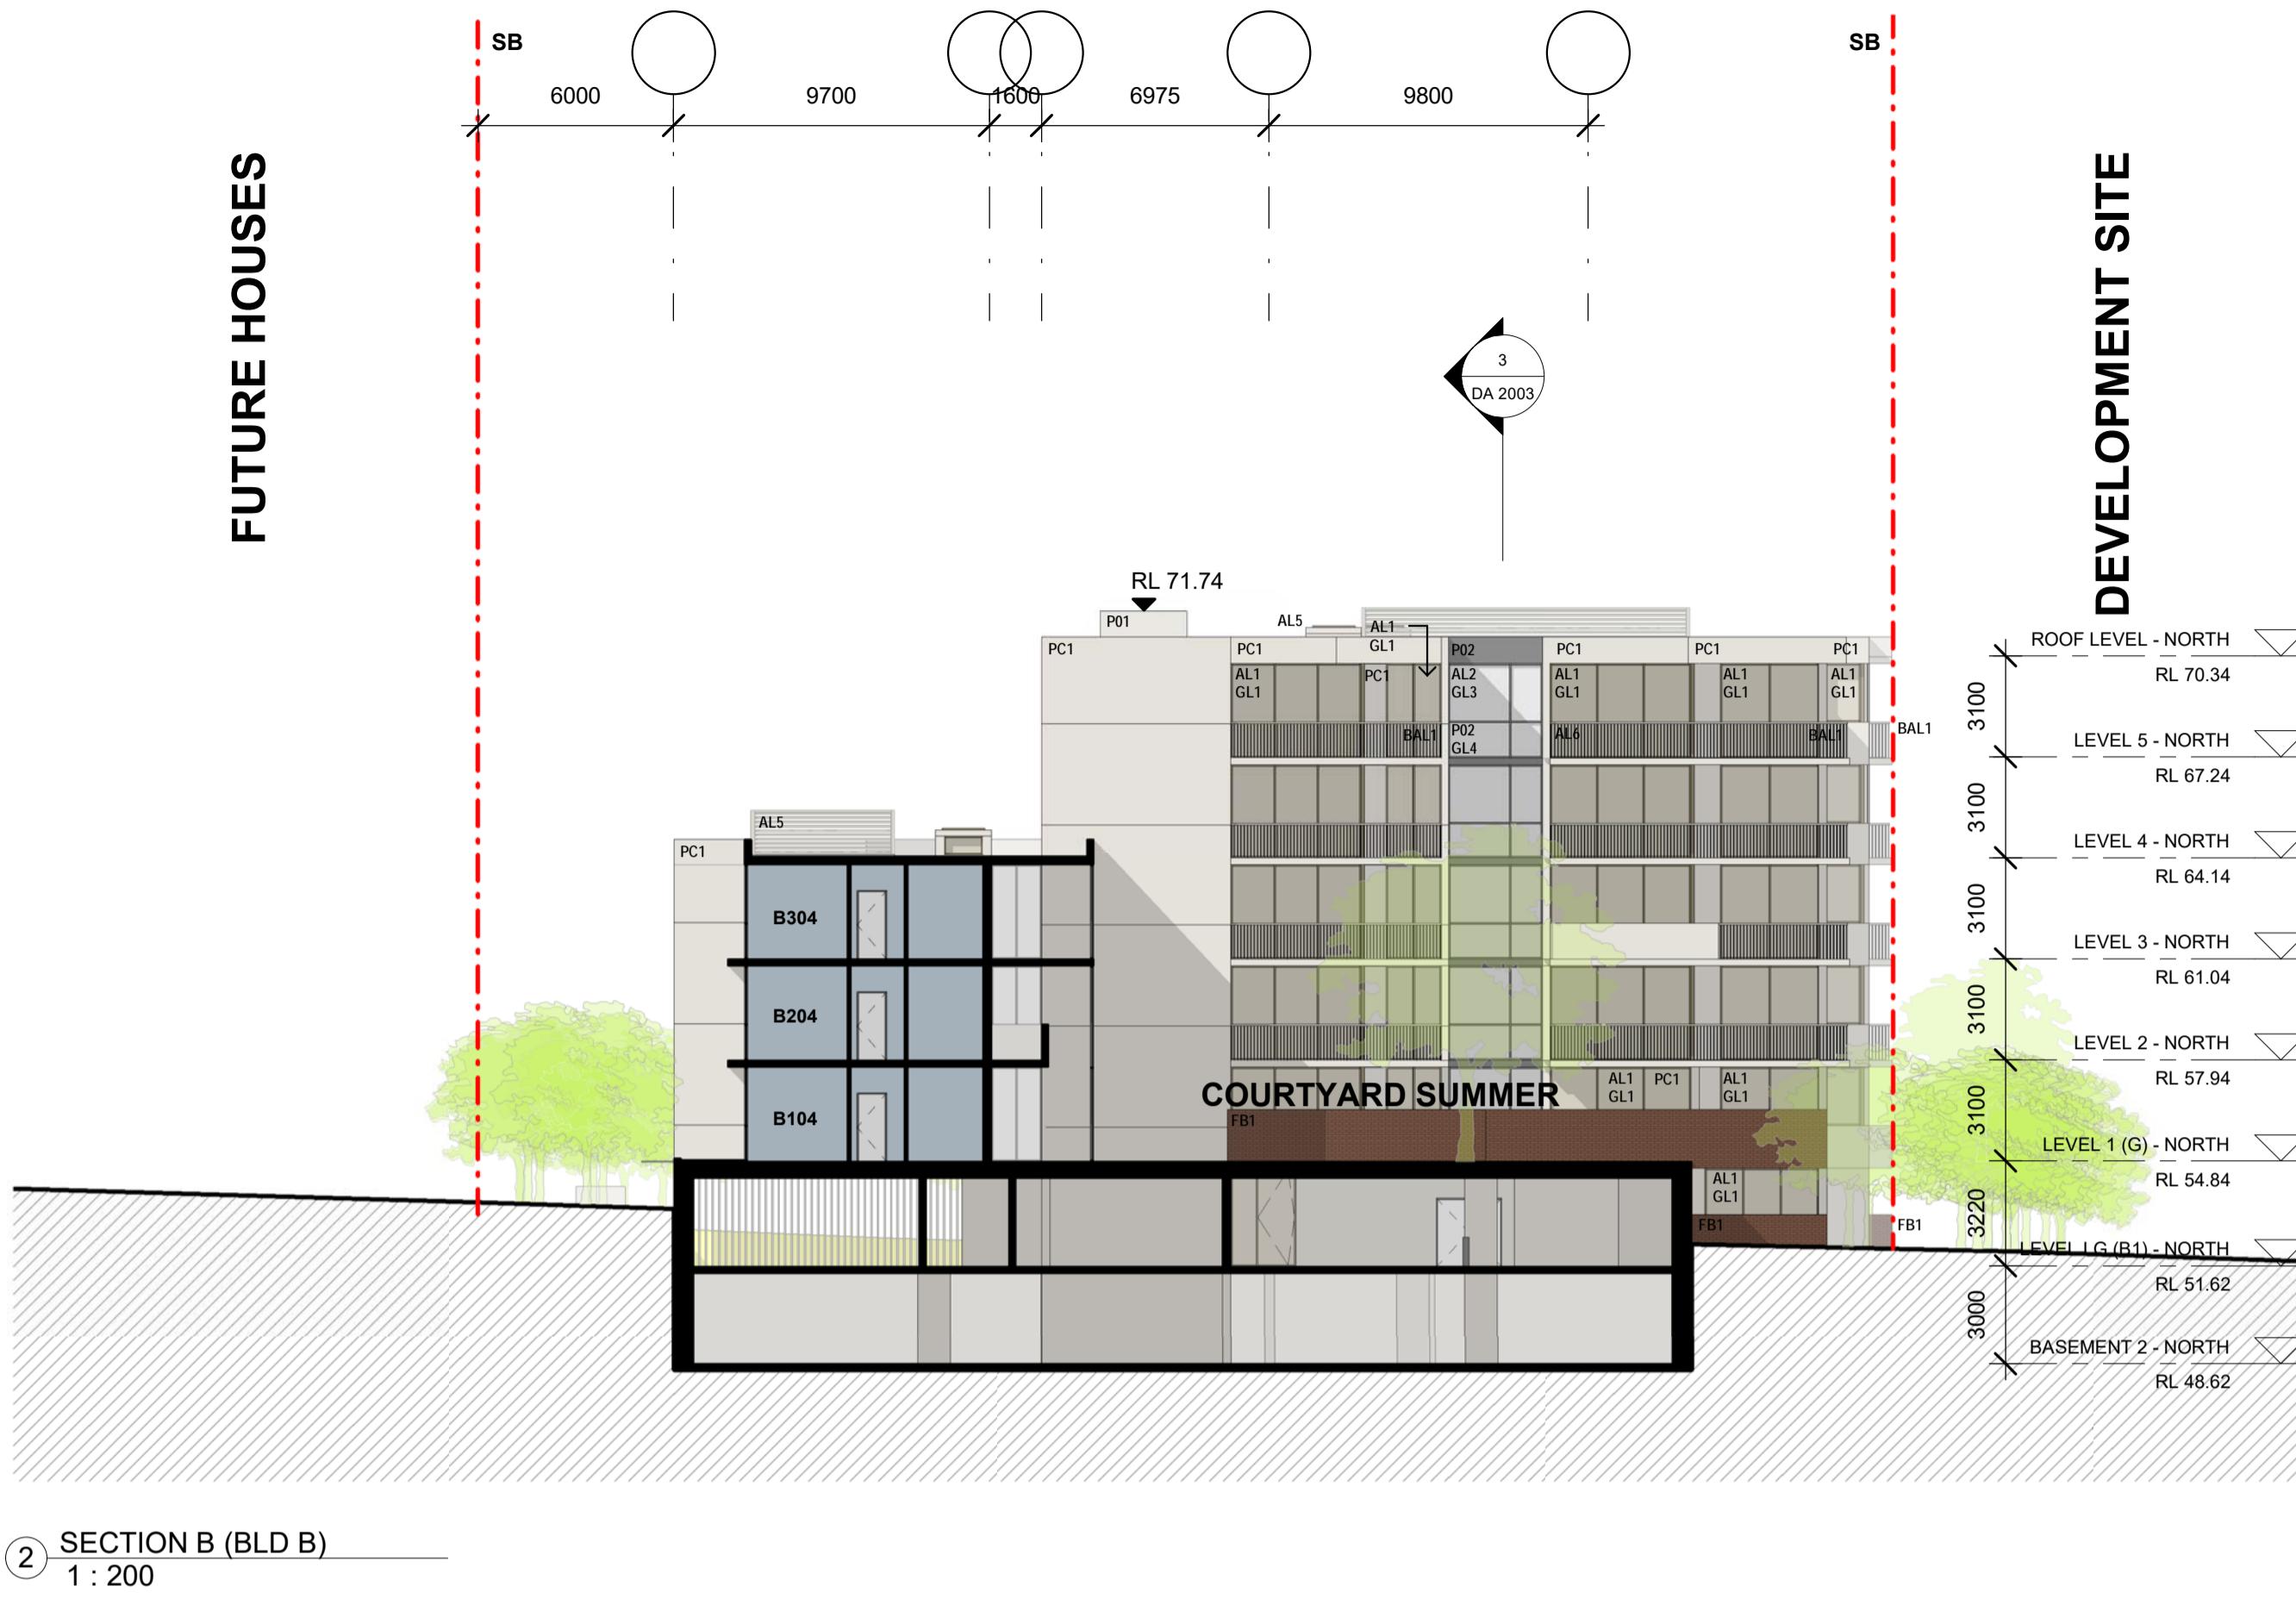


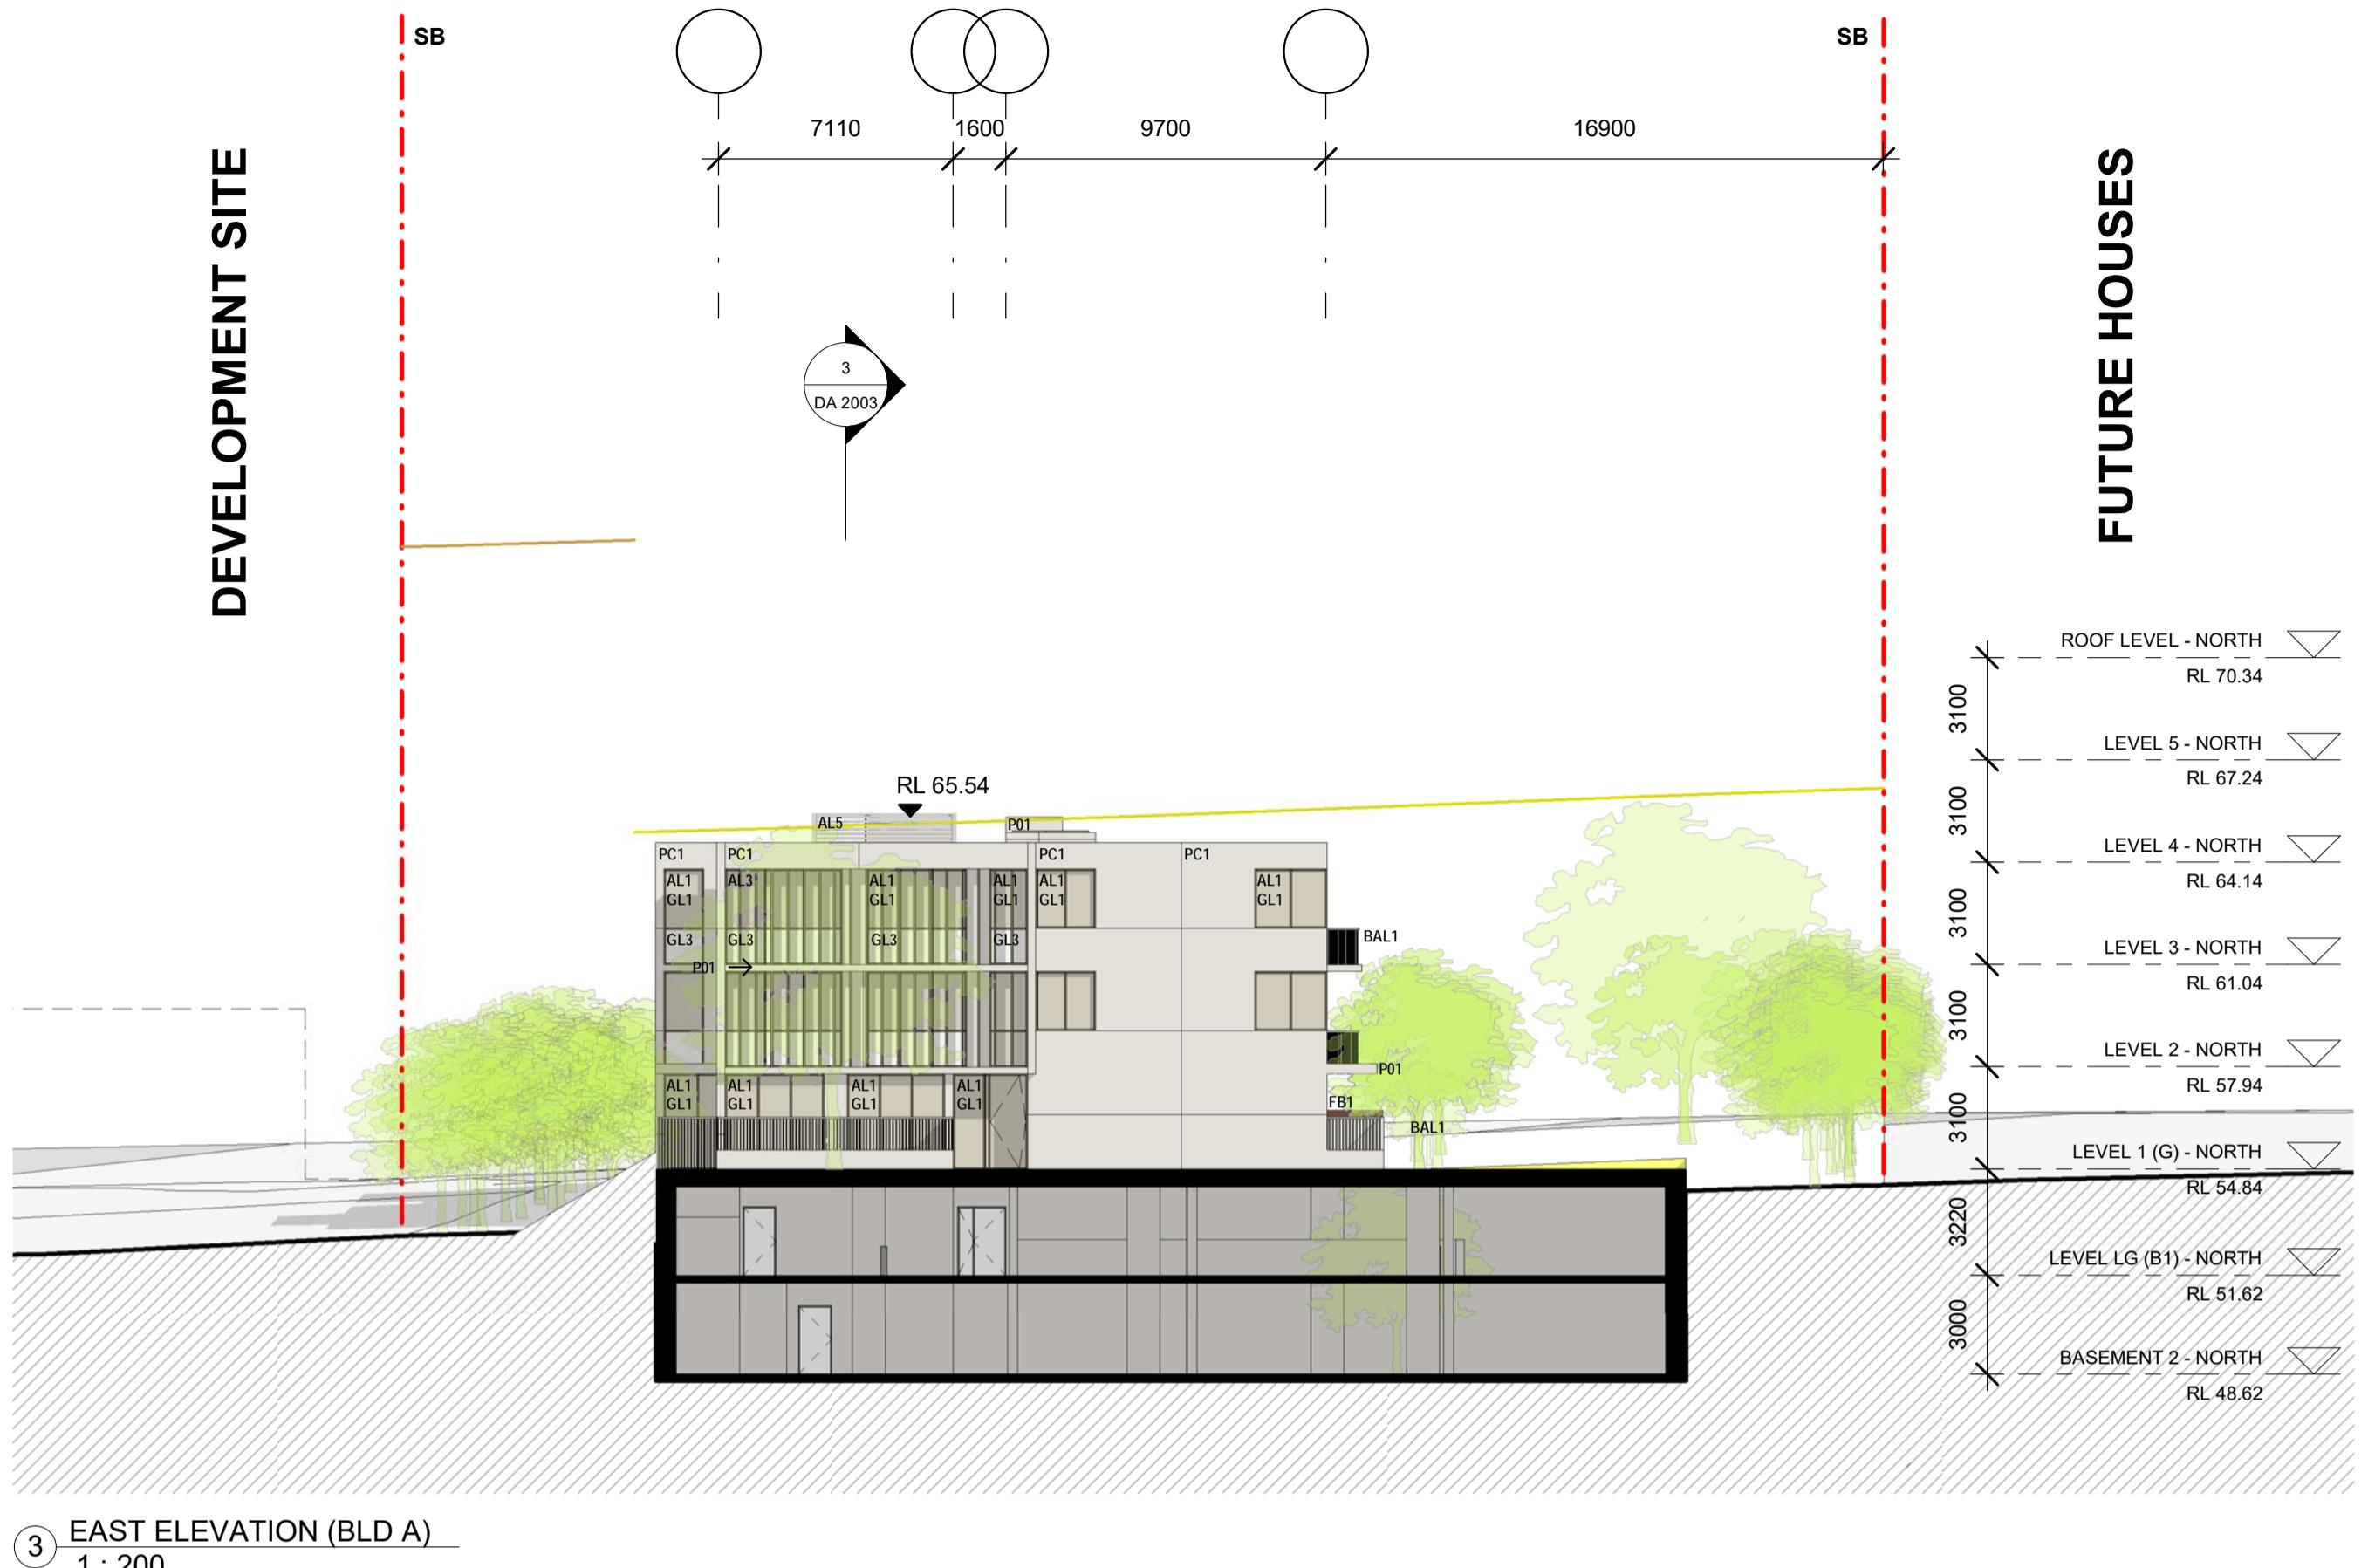③ EAST ELEVATION (BLD A)
1 : 200

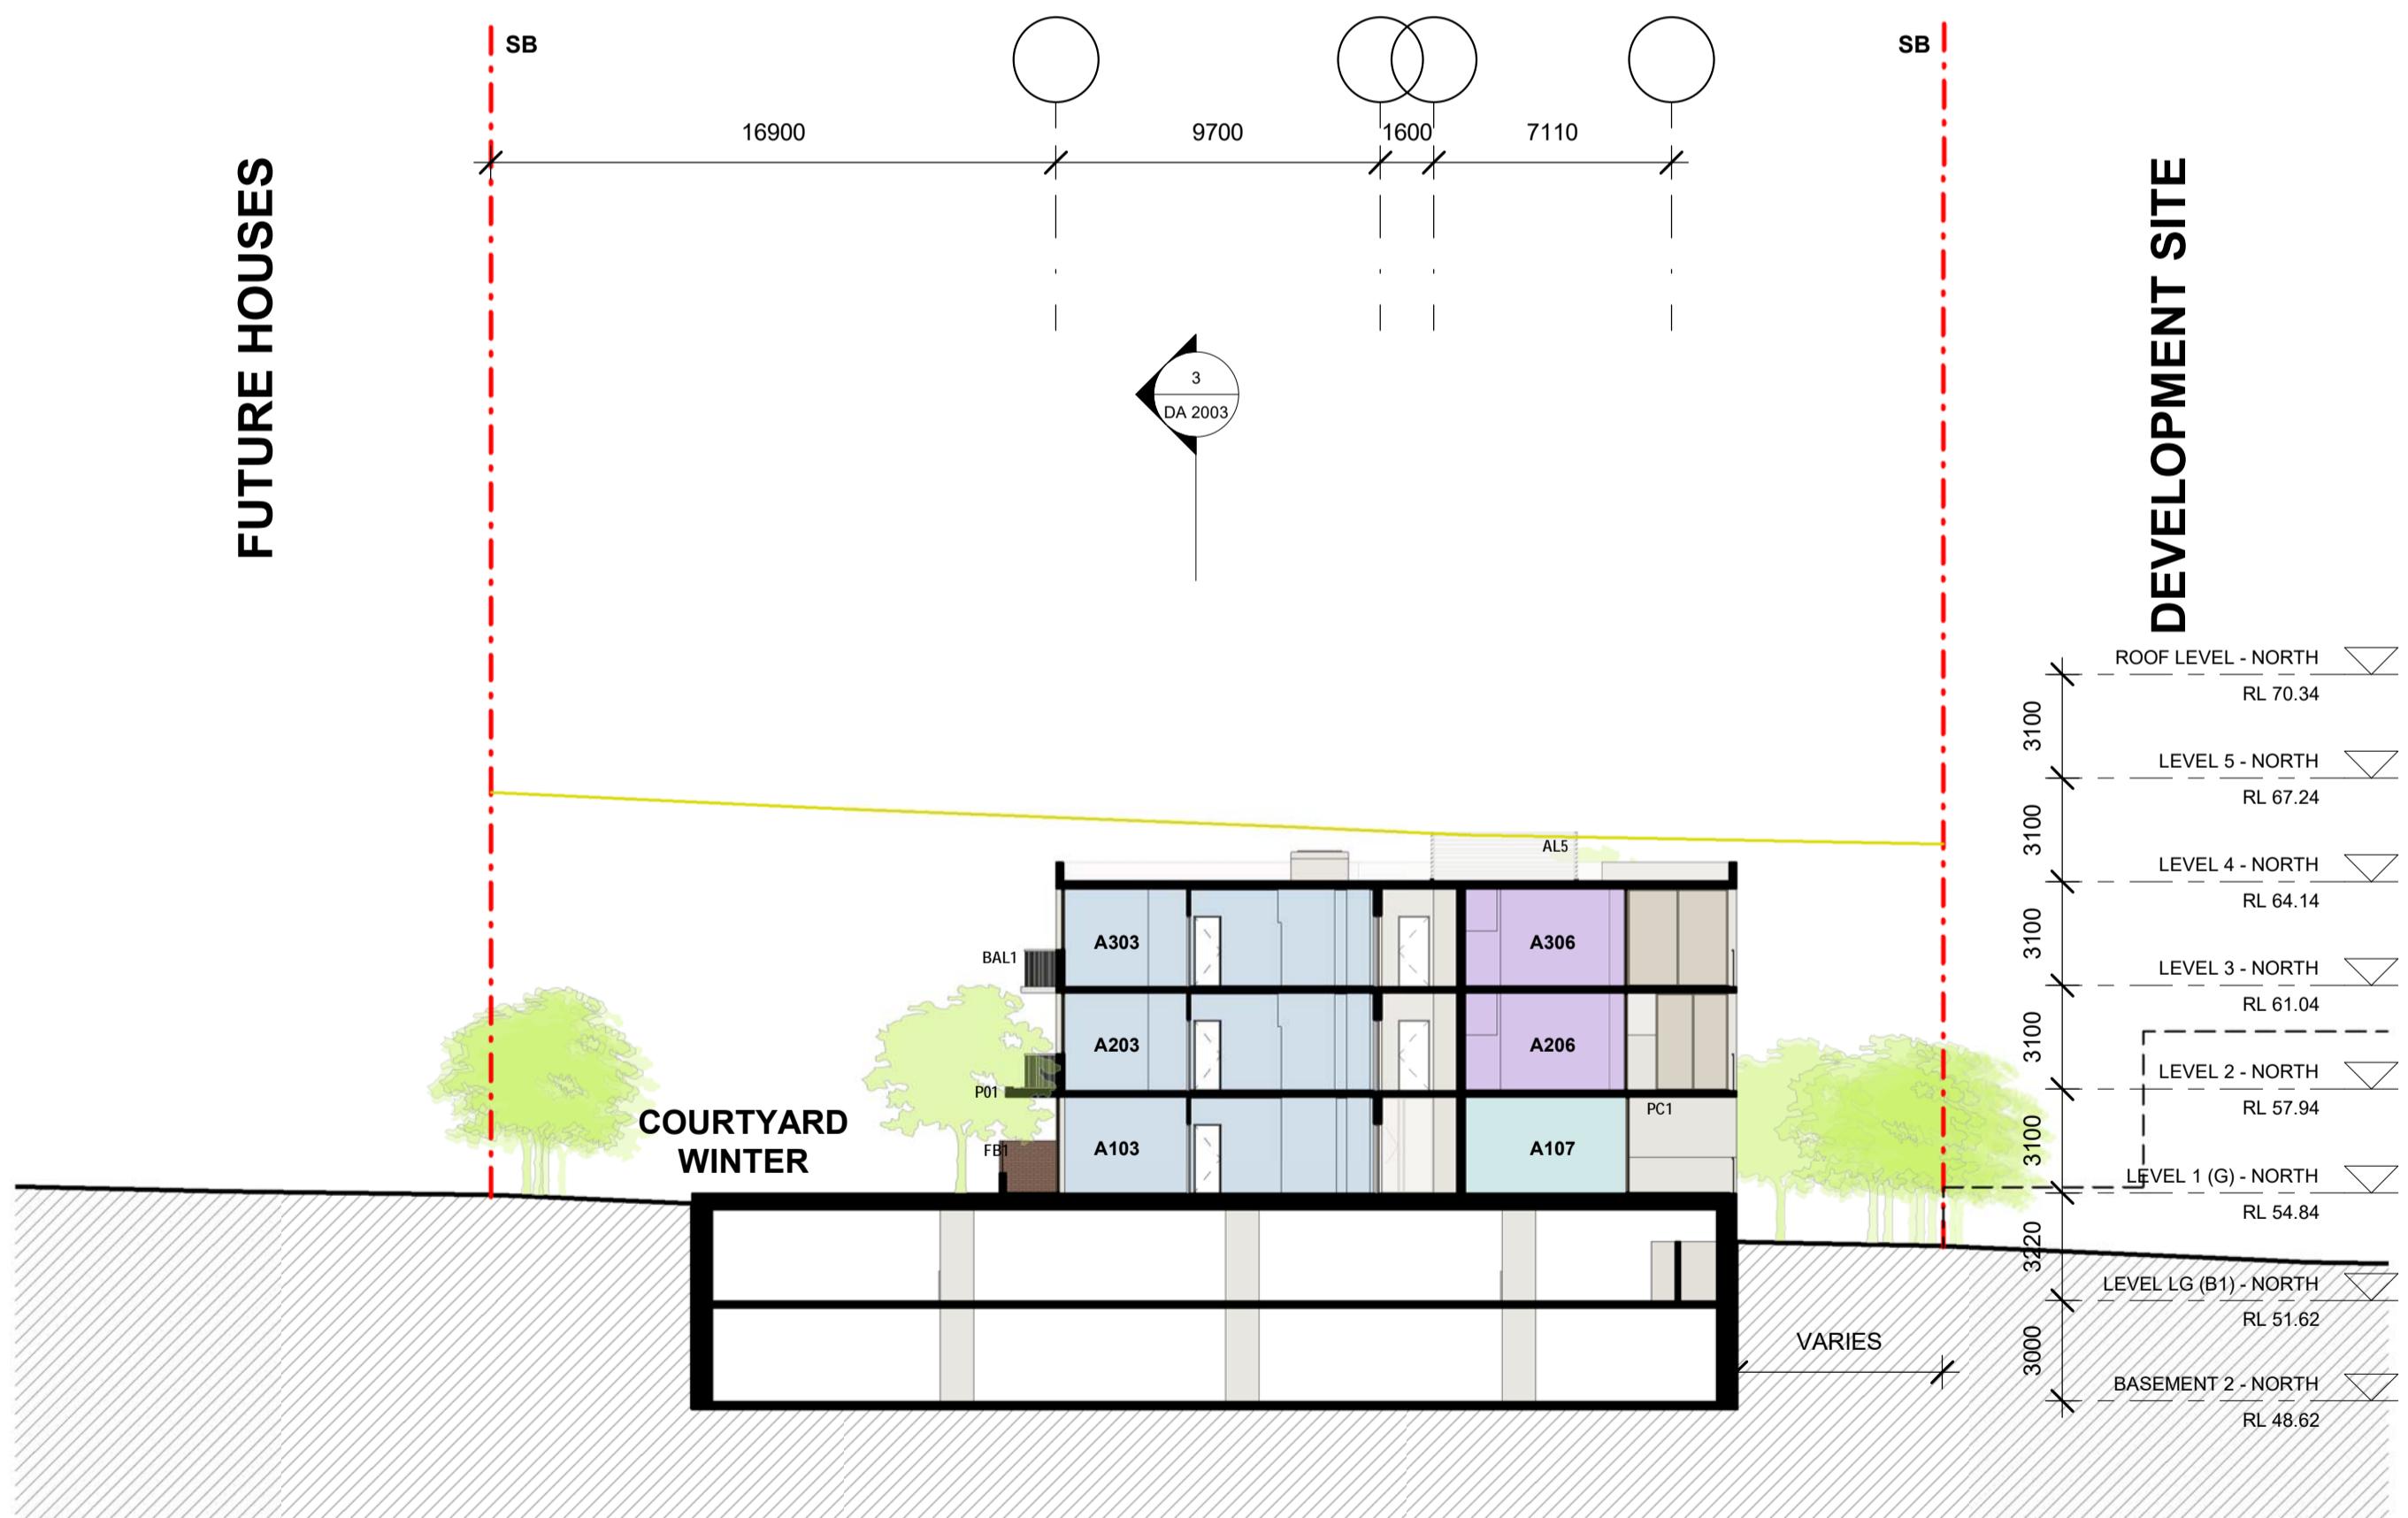

④ SECTION A (BLD A)
1 : 200

project	RESIDENTIAL APARTMENT DEVELOPMENT
LOT 3 DP1259121 SOMME AVENUE + LOT 8 DP1200987 CROATIA AVENUE	EDMONDS PARK
checked	EAST + WEST ELEVATIONS + SECTIONS (BLD A+B)
FS	
scale	1:200 @ A1 1:400 @ A3
drawn	JN
issue	
scale bar	0 2 4 6 8 10 m
project no	20 117
drawing no	



issue	amendment	date	legend	architect	project	
A	ISSUE FOR DEVELOPMENT APPLICATION	03.10.21	AL1 ALUMINIUM FRAMED WINDOWS + DOORS, DULUX, ELECTRO RANGE, DARK BRONZE AL2 ALUMINIUM FRAMED WINDOWS + DOORS, DULUX, ELECTRO RANGE, LIGHT BRONZE AL3 ALUMINIUM FRAMED WINDOWS + DOORS, DULUX, ELECTRO RANGE, MEDIUM BRONZE AL4 ALUMINIUM BATTENS, DULUX, ELECTRO RANGE, MEDIUM BRONZE AL5 ALUMINIUM PLANT SCREEN, DULUX, ELECTRO RANGE, MEDIUM BRONZE BAL1 ALUMINIUM PICKET BALUSTRADE, DULUX ELECTRO RANGE, MEDIUM BRONZE FB1 FACEBRICK, DRY PRESED, BOWRAL BLUE GL1 CLEAR GLASS, VIRIDIAN, BRONZE GL2 TRANSLUCENT GLASS, VIRIDIAN, LUMINA CLOUD, DARK GREY GL3 TRANSLUCENT GLASS, VIRIDIAN, LUMINA CLOUD, BRONZE GL4 TRANSLUCENT GLASS, VIRIDIAN, LUMINA CLOUD, GREY	P01 INSITU CONCRETE, PAINT FINISH, COLOUR TO MATCH PC1 P02 INSITU CONCRETE, PAINT FINISH, COLOUR TO MATCH PC2 PC1 MASONRY, PAINT FINISH, GREY PEBBLE OR SIMILAR PC2 MASONRY, PAINT FINISH, MALAY GREY OR SIMILAR PC3 MASONRY, PAINT FINISH, MUD PACK OR SIMILAR PC4 MASONRY, GROOVES, PAINT FINISH, GREY PEBBLE OR SIMILAR	stanisic architects Level 10, 257 Clarence Street, Sydney NSW 2000 T (61 2) 9358 2588 E info@stanisic.com.au ABN 11002633481 NSW ARB Frank Stanisic 4480	RESIDENTIAL APARTMENT DEVELOPMENT LOT 3 DP1259121 SOMME AVENUE + LOT 8 DP1200987 CROATIA AVENUE EDMONDS PARK
				client	checked drawing FS	
				CROATIA 88 PTY LTD	scale 1:200 @ A1 1:400 @ A3 drawn JN issue	
				scale bar 0 2 4 6 8 10 m	project no 20 117 drawing no	
do not scale from drawings.						
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03-Nov-21 4:03:22 PM						
DA 2003						



issue amendment date

A ISSUE FOR DEVELOPMENT APPLICATION 03.10.21

legend

AL1 ALUMINUM FRAMED WINDOWS + DOORS, DULUX, ELECTRO RANGE, DARK BRONZE
AL2 ALUMINUM FRAMED WINDOWS + DOORS, DULUX, ELECTRO RANGE, LIGHT BRONZE
AL3 ALUMINUM FRAMED WINDOWS + DOORS, DULUX, ELECTRO RANGE, MEDIUM BRONZE
AL4 ALUMINUM BATTENS, DULUX, ELECTRO RANGE, MEDIUM BRONZE
AL5 ALUMINUM PLANT SCREEN, DULUX, ELECTRO RANGE, MEDIUM BRONZE
BAL1 ALUMINUM PICKET BALUSTRADE, DULUX ELECTRO RANGE, MEDIUM BRONZE
FB1 FACEBRICK, DRY PRESSED, BOWRAL BLUE
GL1 CLEAR GLASS, VIRIDIAN, BRONZE
GL2 TRANSLUCENT GLASS, VIRIDIAN, LUMINA CLOUD, DARK GREY
GL3 TRANSLUCENT GLASS, VIRIDIAN, LUMINA CLOUD, BRONZE
GL4 TRANSLUCENT GLASS, VIRIDIAN, LUMINA CLOUD, GREY

12M HEIGHT FROM NATURAL GROUND LINE
21M HEIGHT FROM NATURAL GROUND LINE

architect

stanisic architects

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client

CROATIA 88 PTY LTD

project RESIDENTIAL APARTMENT DEVELOPMENT
LOT 3 DP1259121 SOMME AVENUE + LOT 8 DP1200987 CROATIA AVENUE
EDMONDSON PARK

checked drawing
FS
NORTH + SOUTH ELEVATION (BLD C)

scale 1:200@A1
1:400@A3


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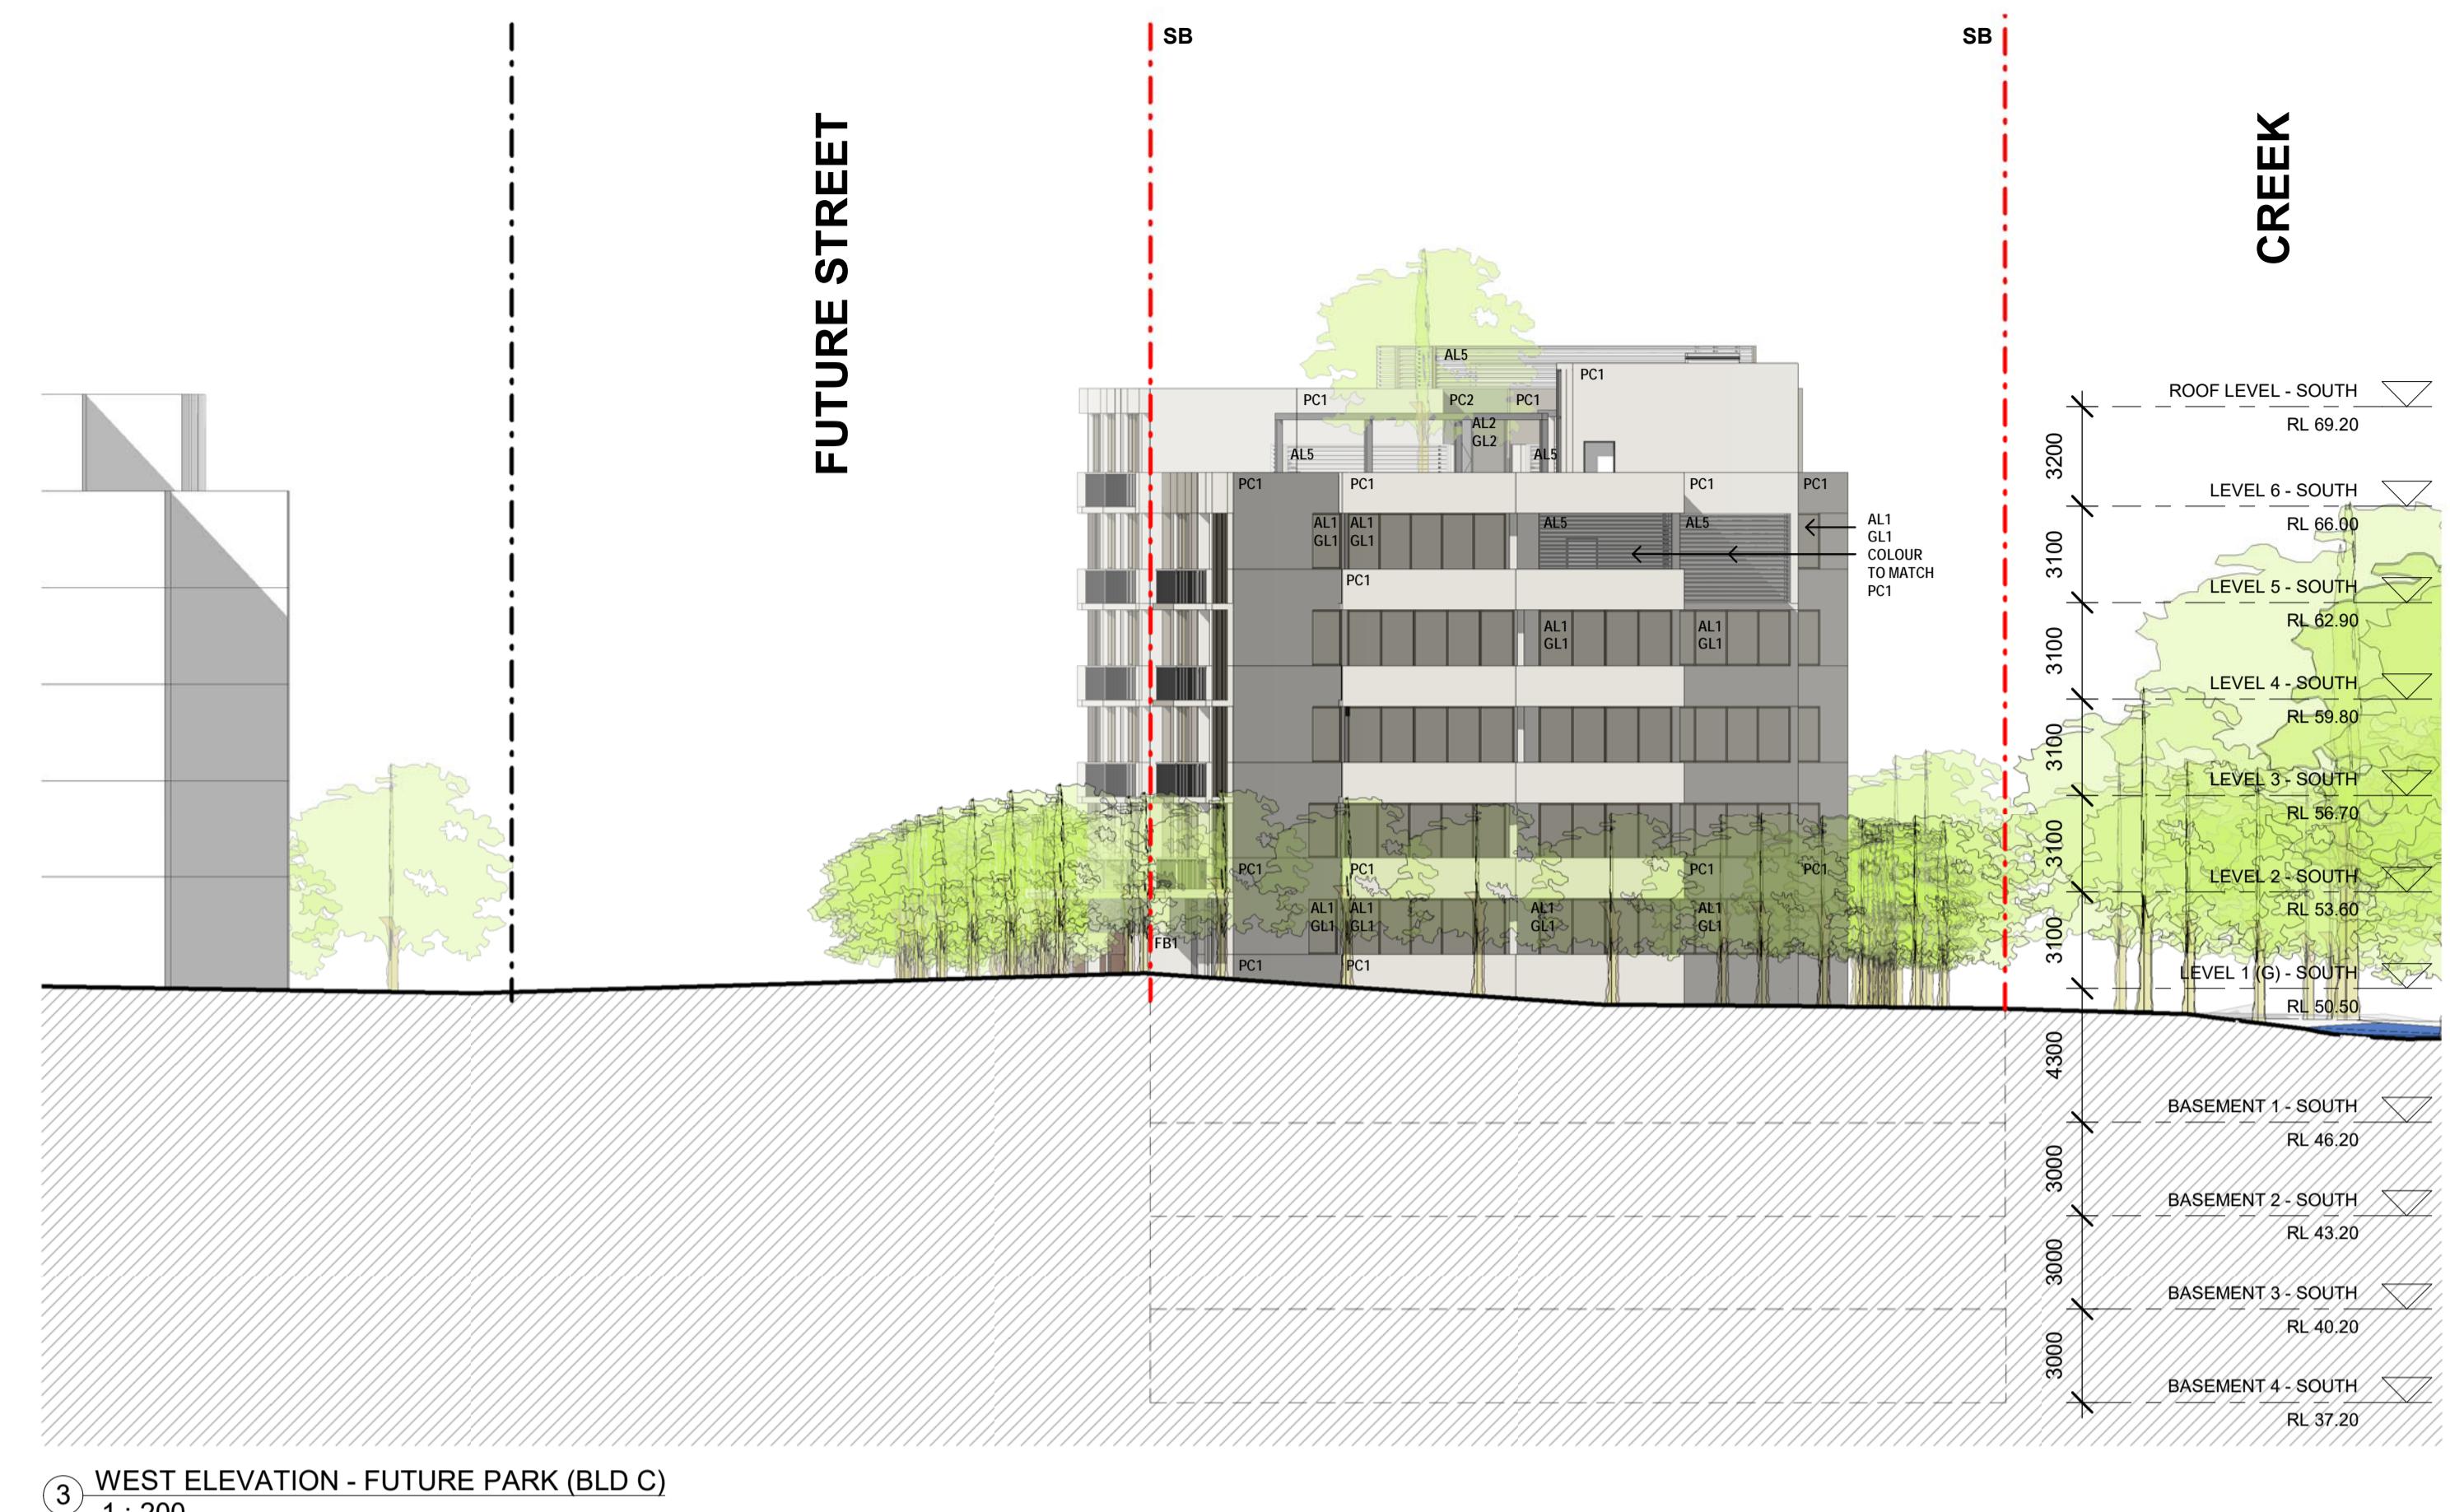
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20 117 drawing no


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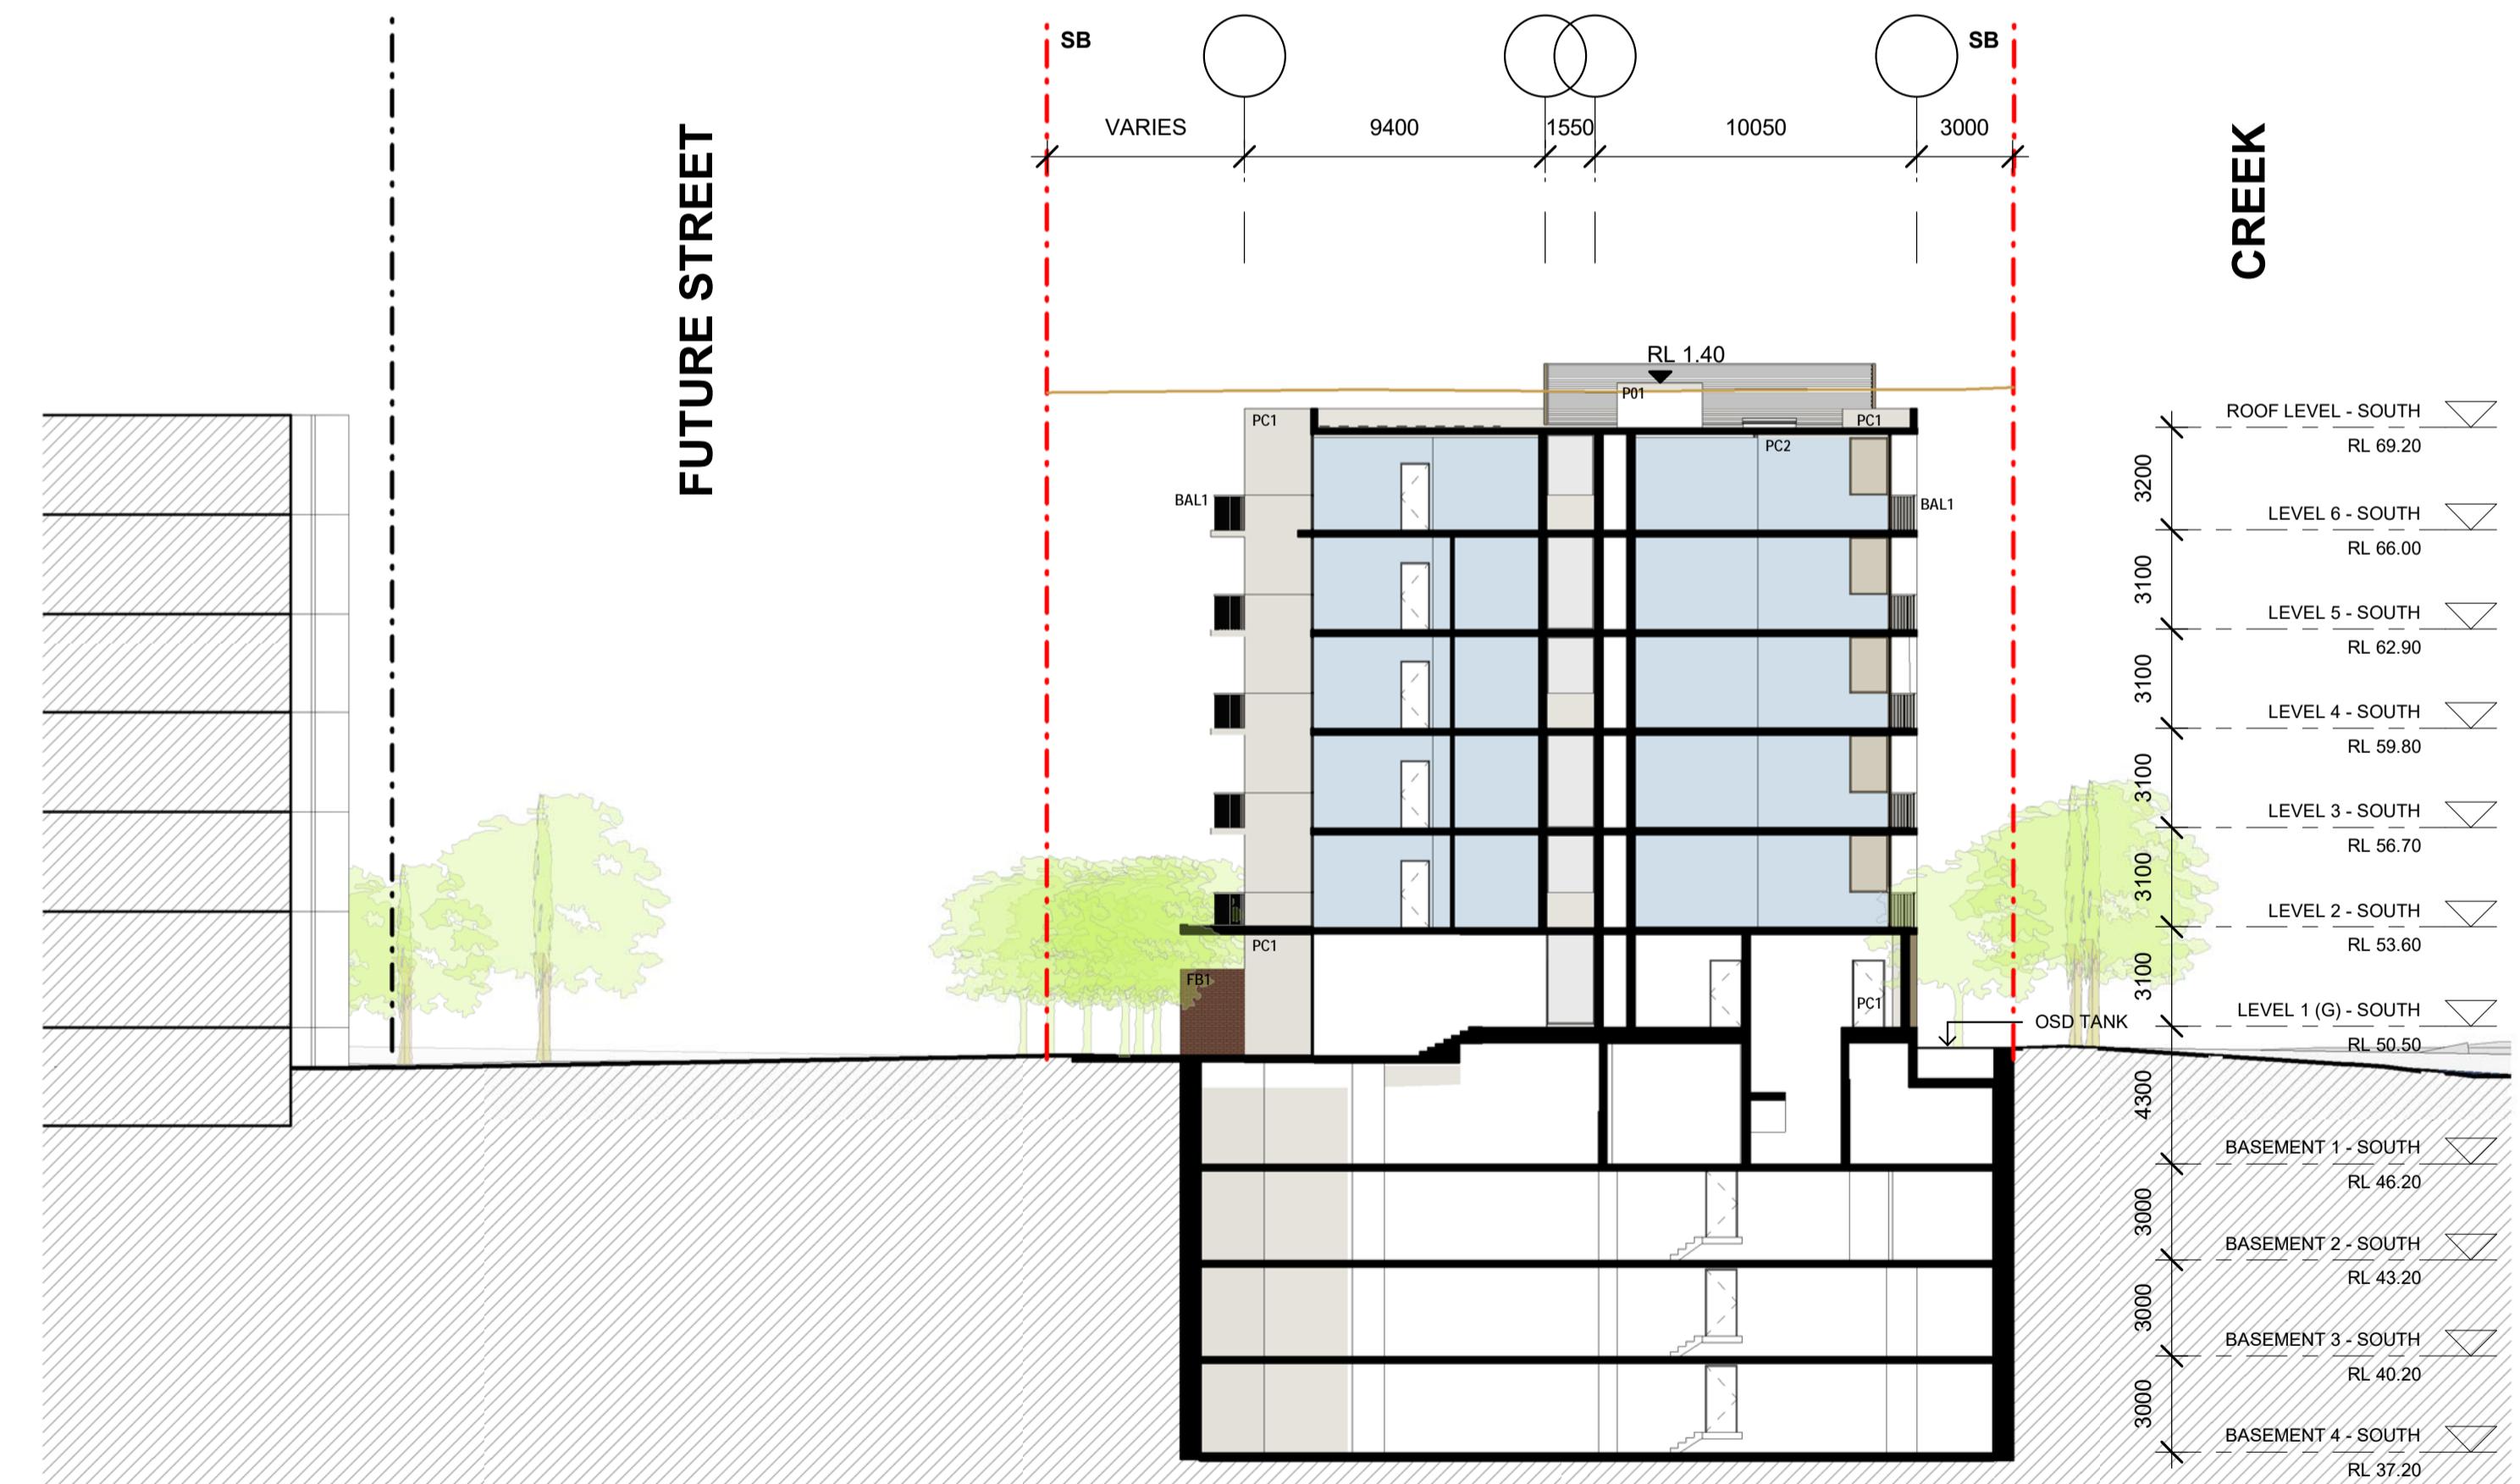
① EAST ELEVATION - BERNERA RD (BLD C)
1 : 200



③ WEST ELEVATION - FUTURE PARK (BLD C)
1 : 200

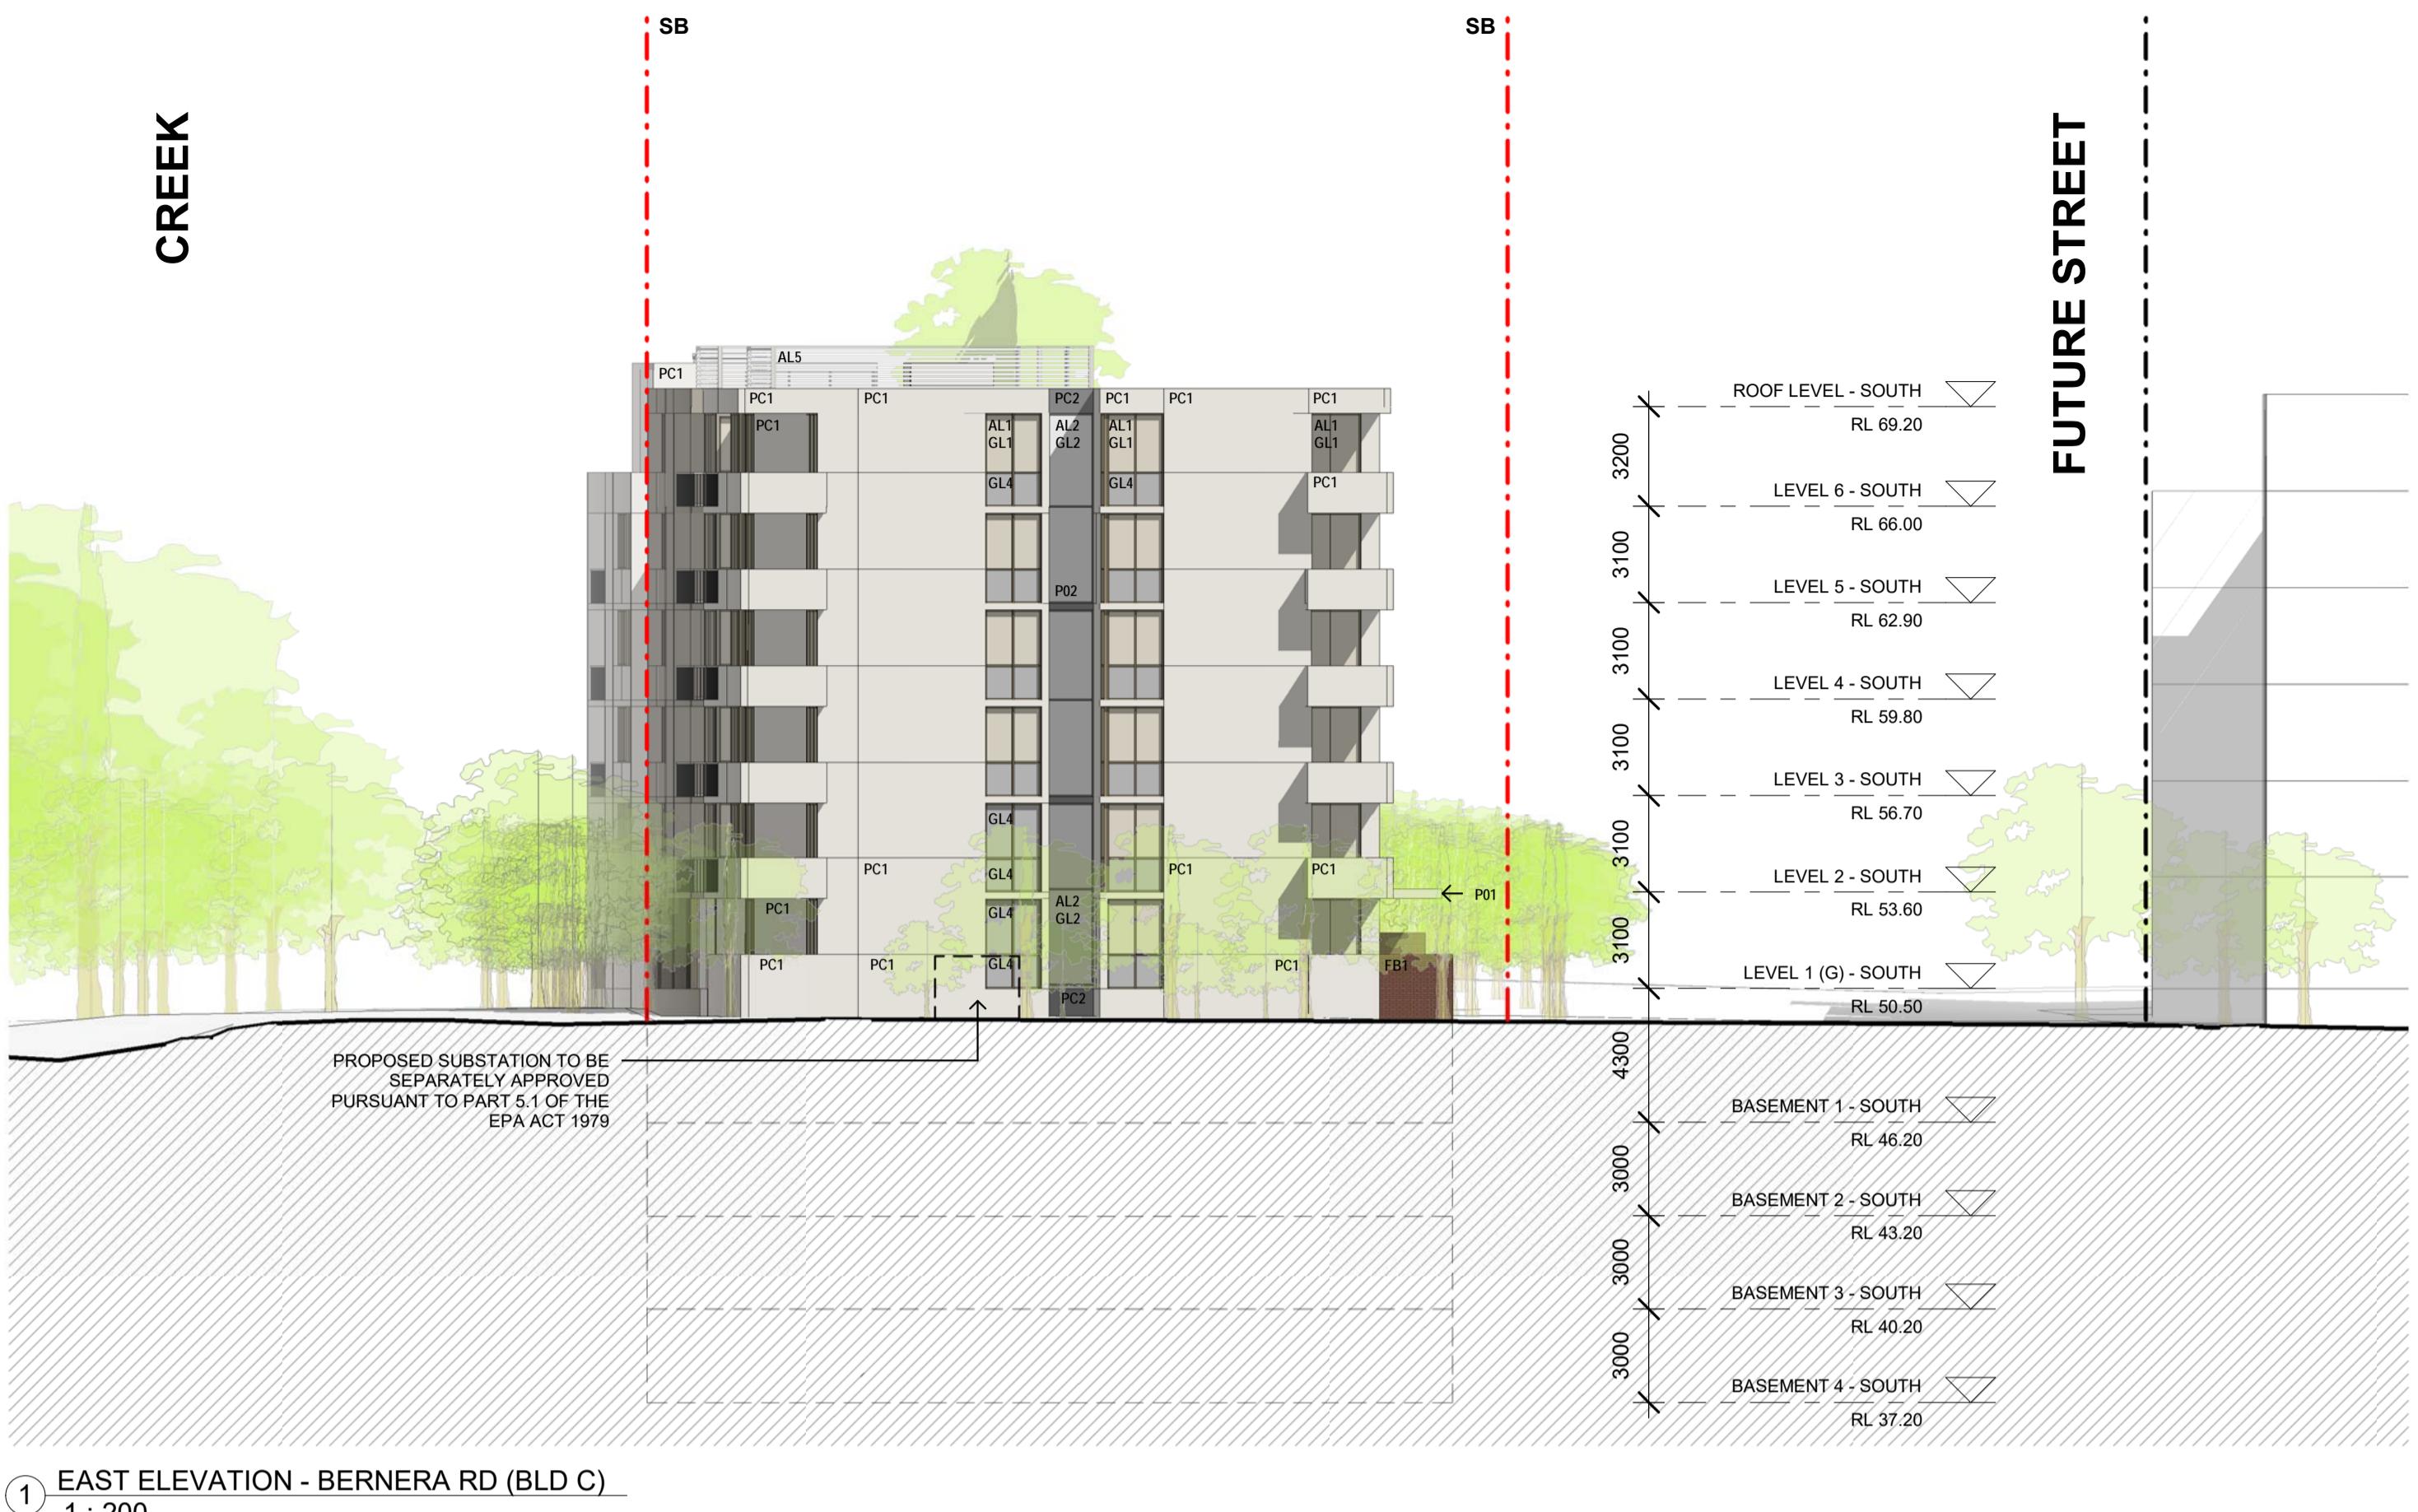

② SECTION A (BLD C)
1 : 200

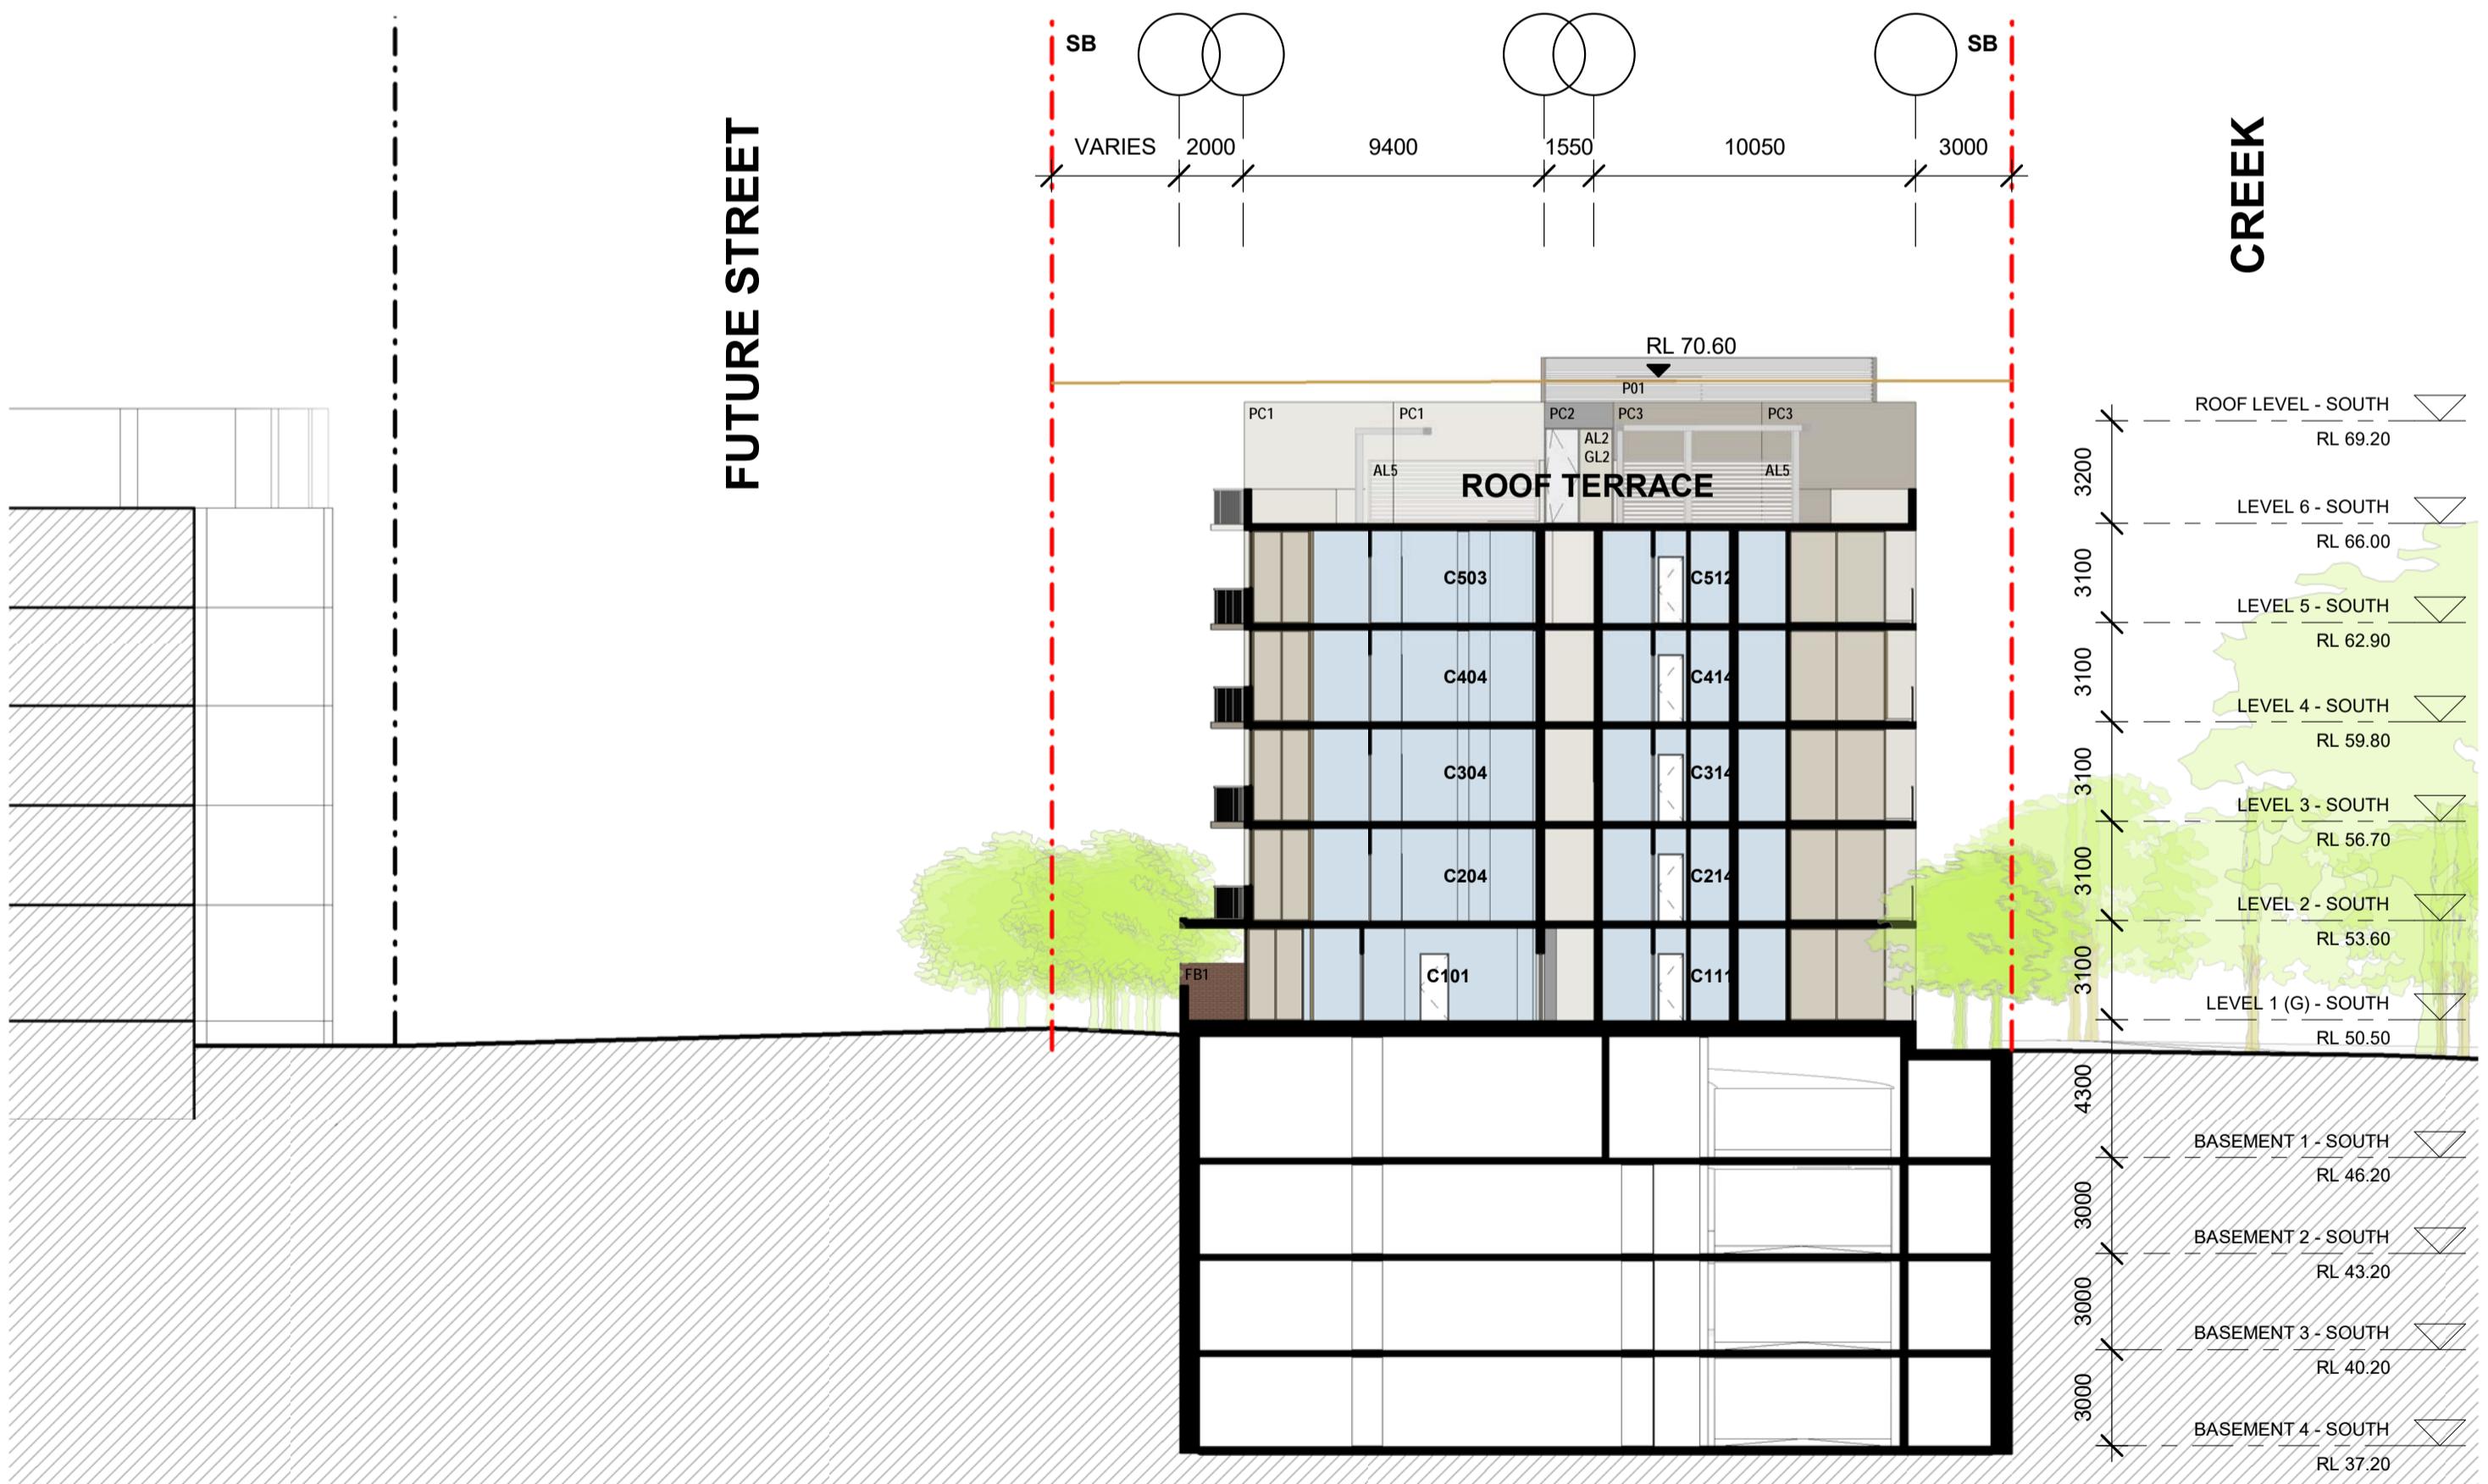

④ SECTION B (BLD C)
1 : 200

issue amendment date legend
A ISSUE FOR DEVELOPMENT APPLICATION 03.10.21
AL1 ALUMINIUM FRAMED WINDOWS + DOORS, DULUX, ELECTRO RANGE, DARK BRONZE
AL2 ALUMINIUM FRAMED WINDOWS + DOORS, DULUX, ELECTRO RANGE, LIGHT BRONZE
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AL5 ALUMINIUM PLANT SCREEN, DULUX, ELECTRO RANGE, MEDIUM BRONZE
BAL1 ALUMINIUM PICKET BALUSTRADE, DULUX ELECTRO RANGE, MEDIUM BRONZE
FB1 FACEBRICK, DRY PRESENTED BOWRAL BLUE
GL1 CLEAR GLASS, VIRIDIAN, BRONZE
GL2 TRANSLUCENT GLASS, VIRIDIAN, LUMINA CLOUD, DARK GREY
GL3 TRANSLUCENT GLASS, VIRIDIAN, LUMINA CLOUD, BRONZE
GL4 TRANSLUCENT GLASS, VIRIDIAN, LUMINA CLOUD, GREY

12M HEIGHT FROM NATURAL GROUND LINE
21M HEIGHT FROM NATURAL GROUND LINE

do not scale from drawings.





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project RESIDENTIAL APARTMENT DEVELOPMENT
LOT 3 DP1259121 SOMME AVENUE + LOT 8 DP1200987 CROATIA AVENUE
EDMONDSON PARK
checked drawing
FS
EAST + WEST ELEVATION + SECTIONS (BLD C)

scale 1:200@A1
1:400@A3
drawn JN
issue
scale bar 0 2 4 6 8 10 m
project no 20 117
drawing no DA 2102



issue amendment date legend

A ISSUE FOR DEVELOPMENT APPLICATION 03.10.21

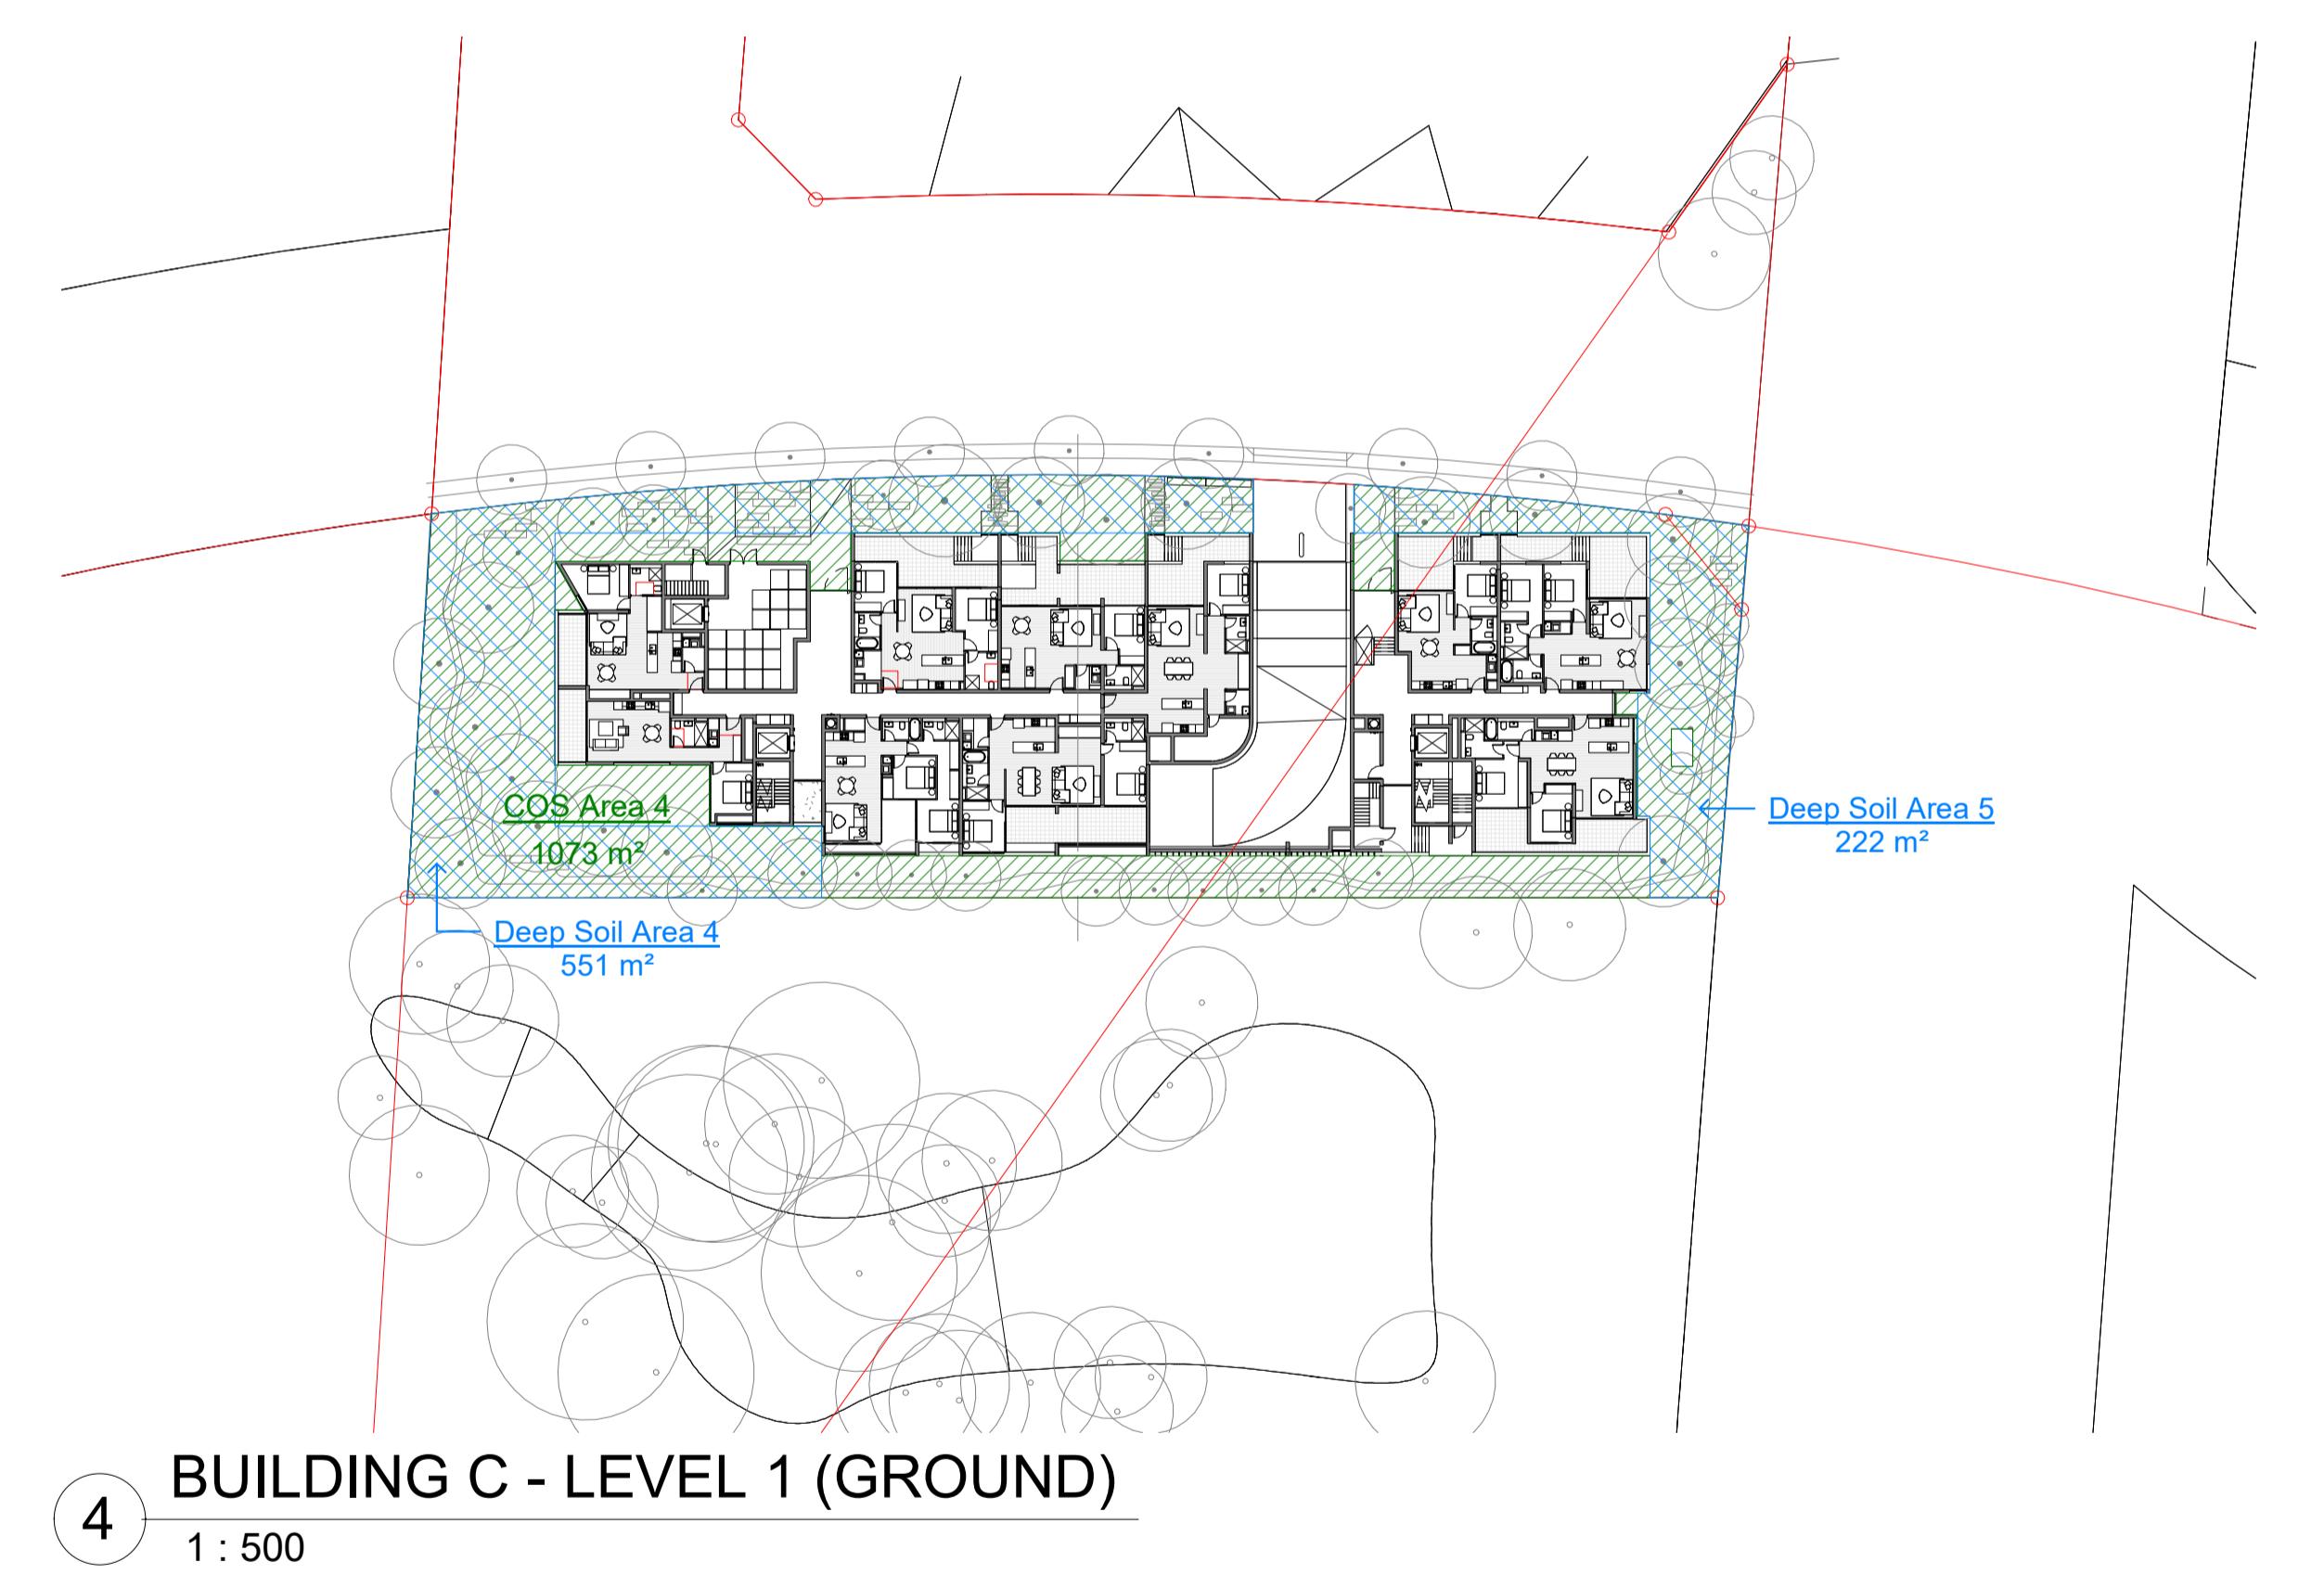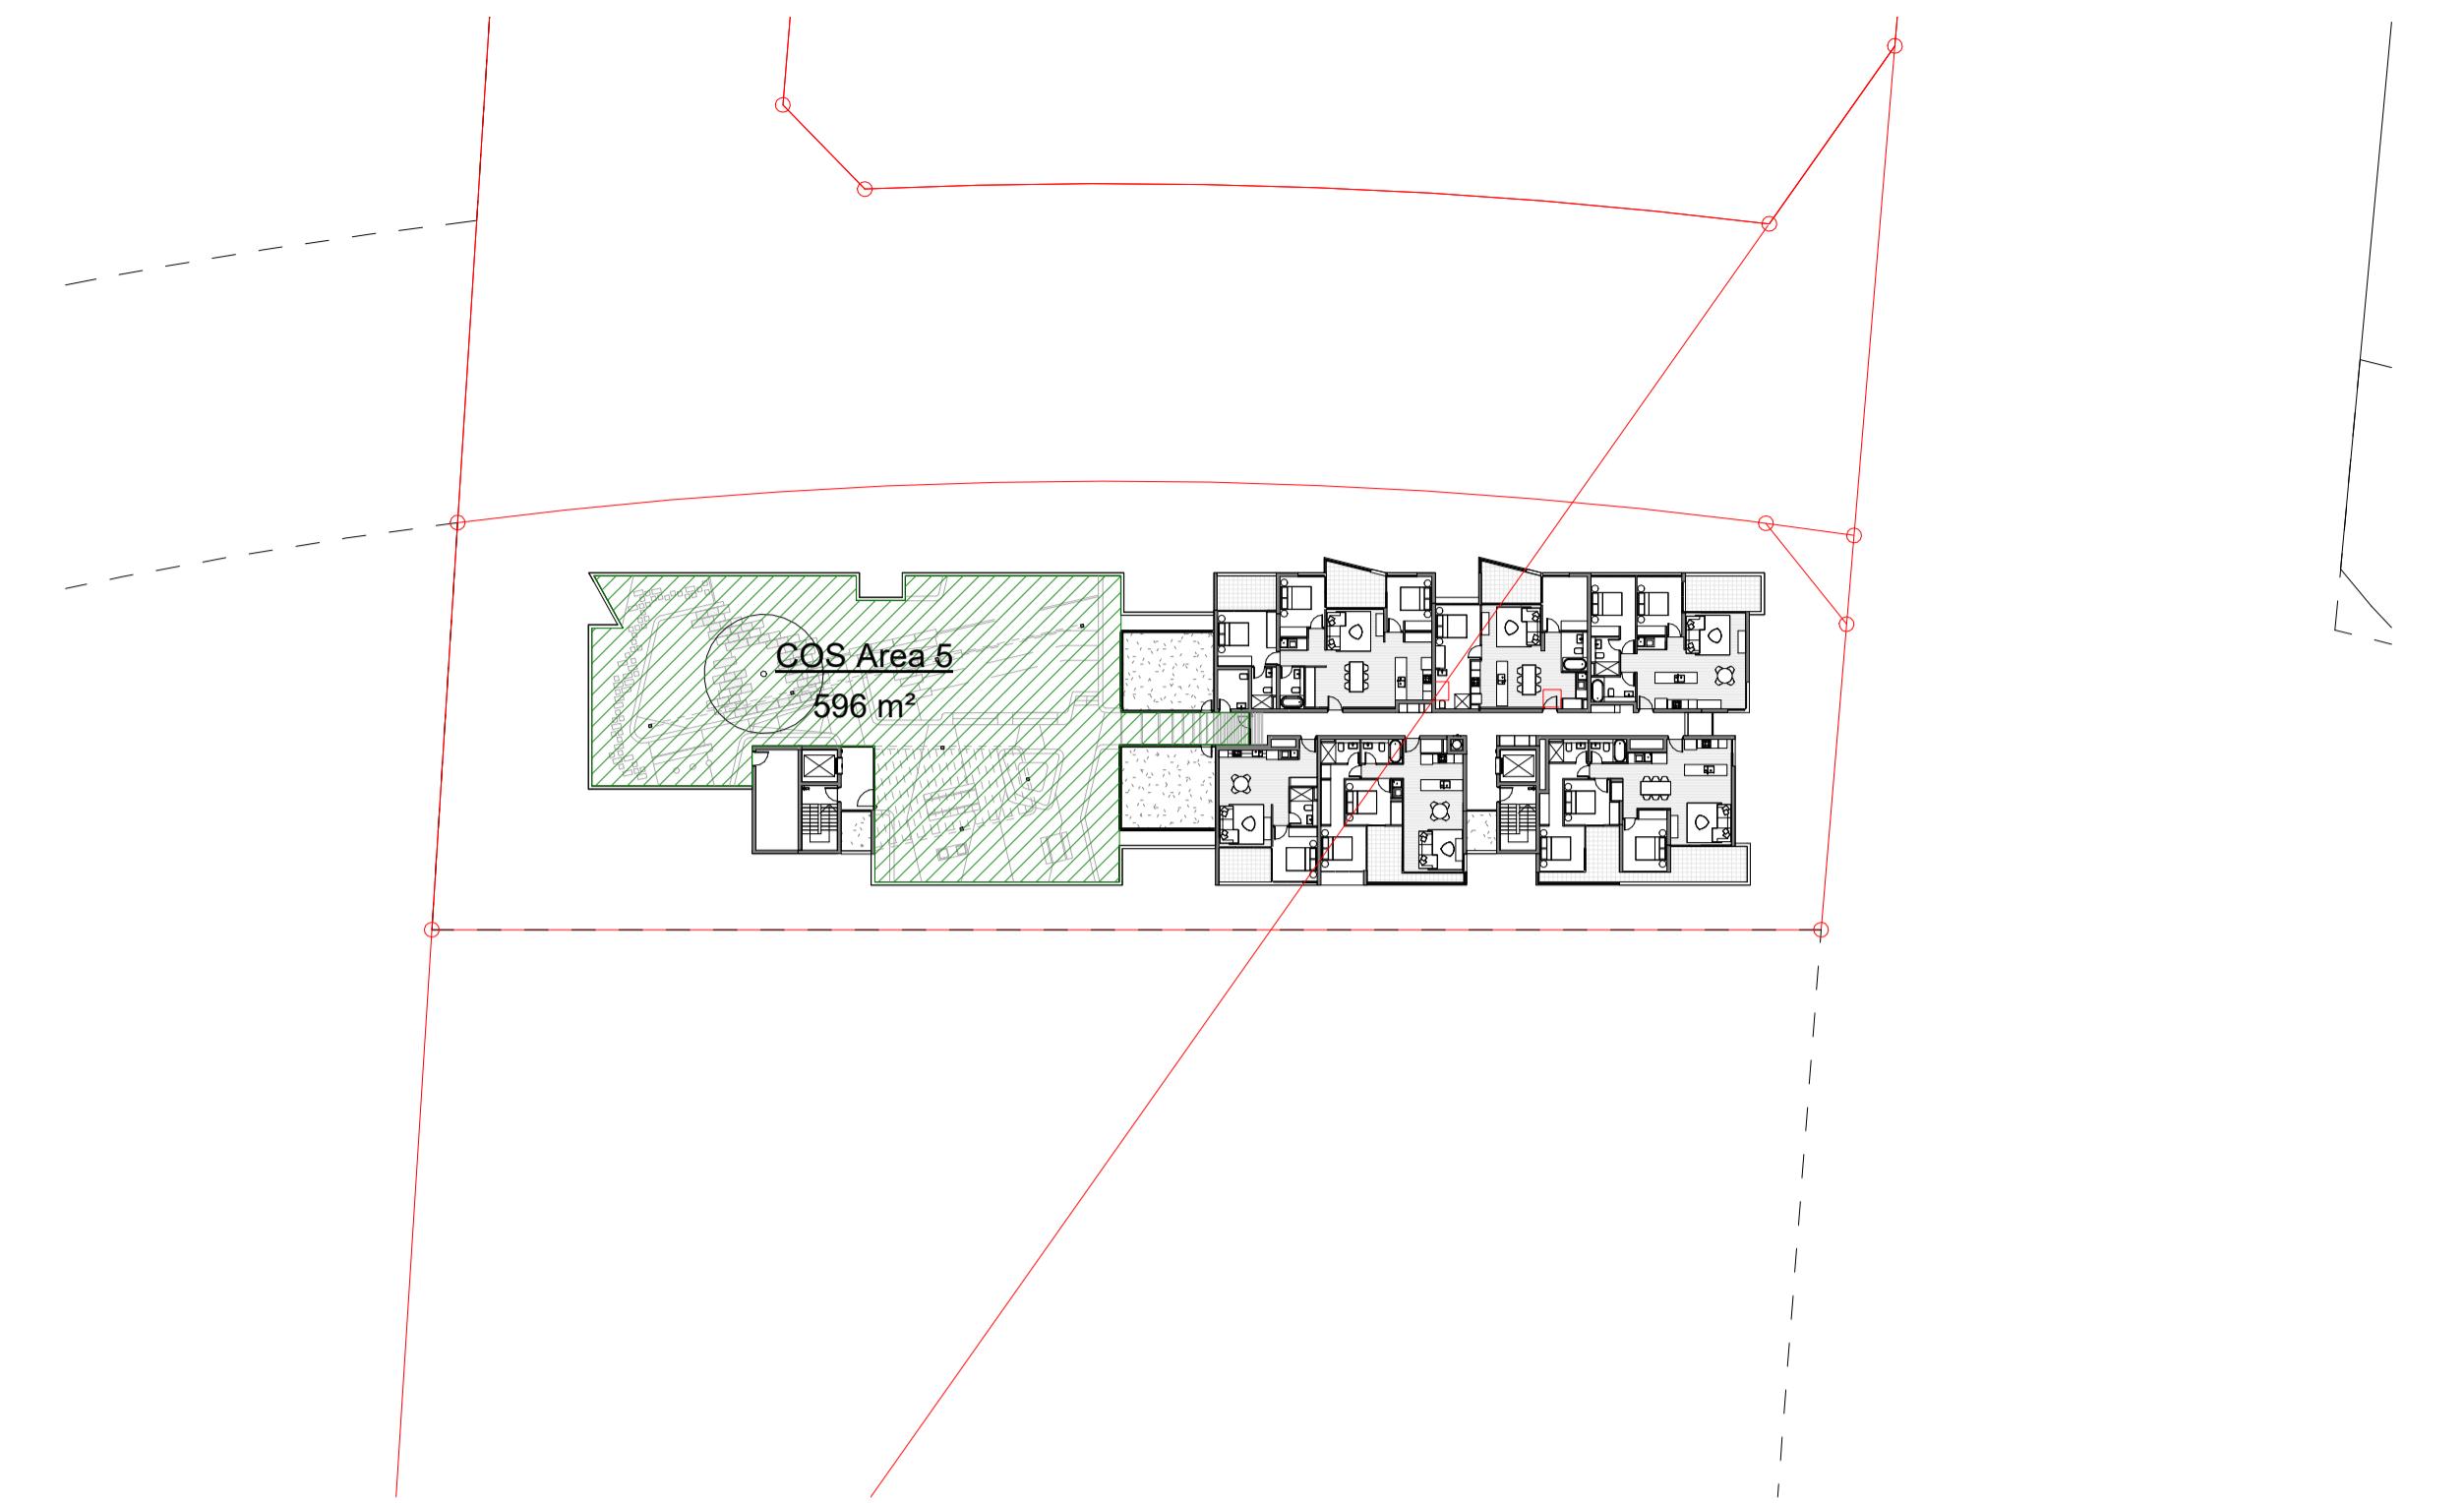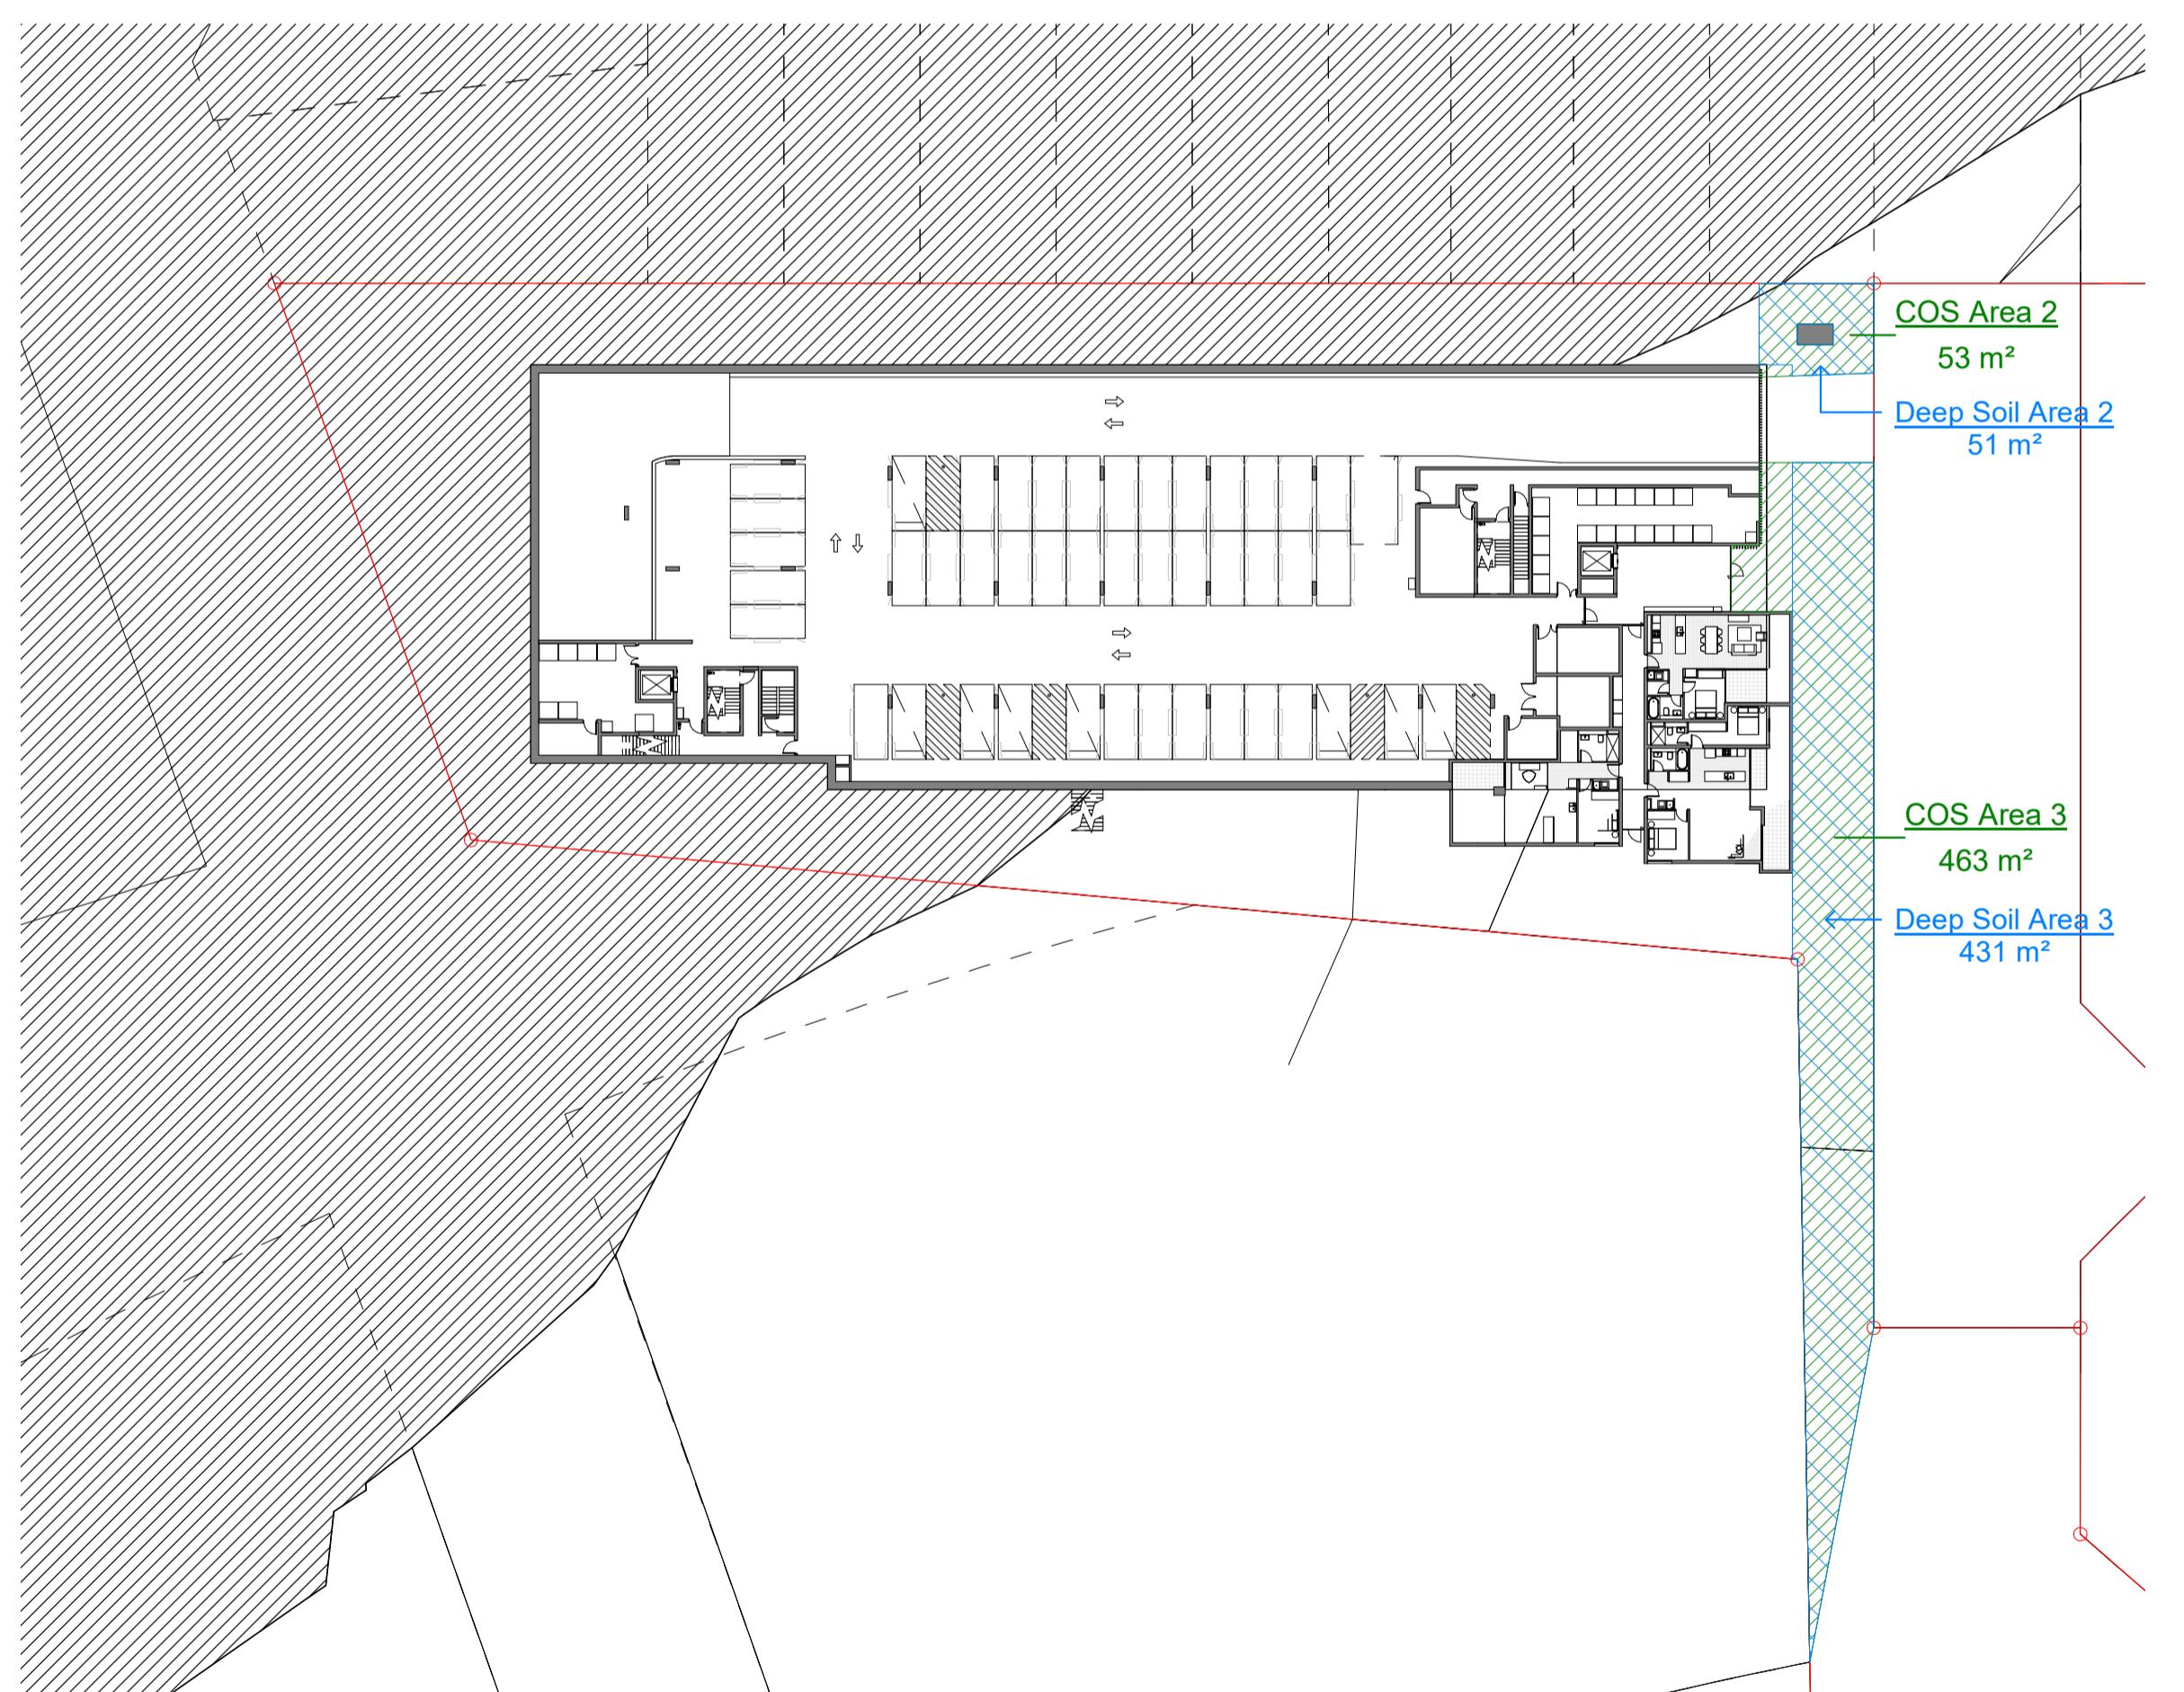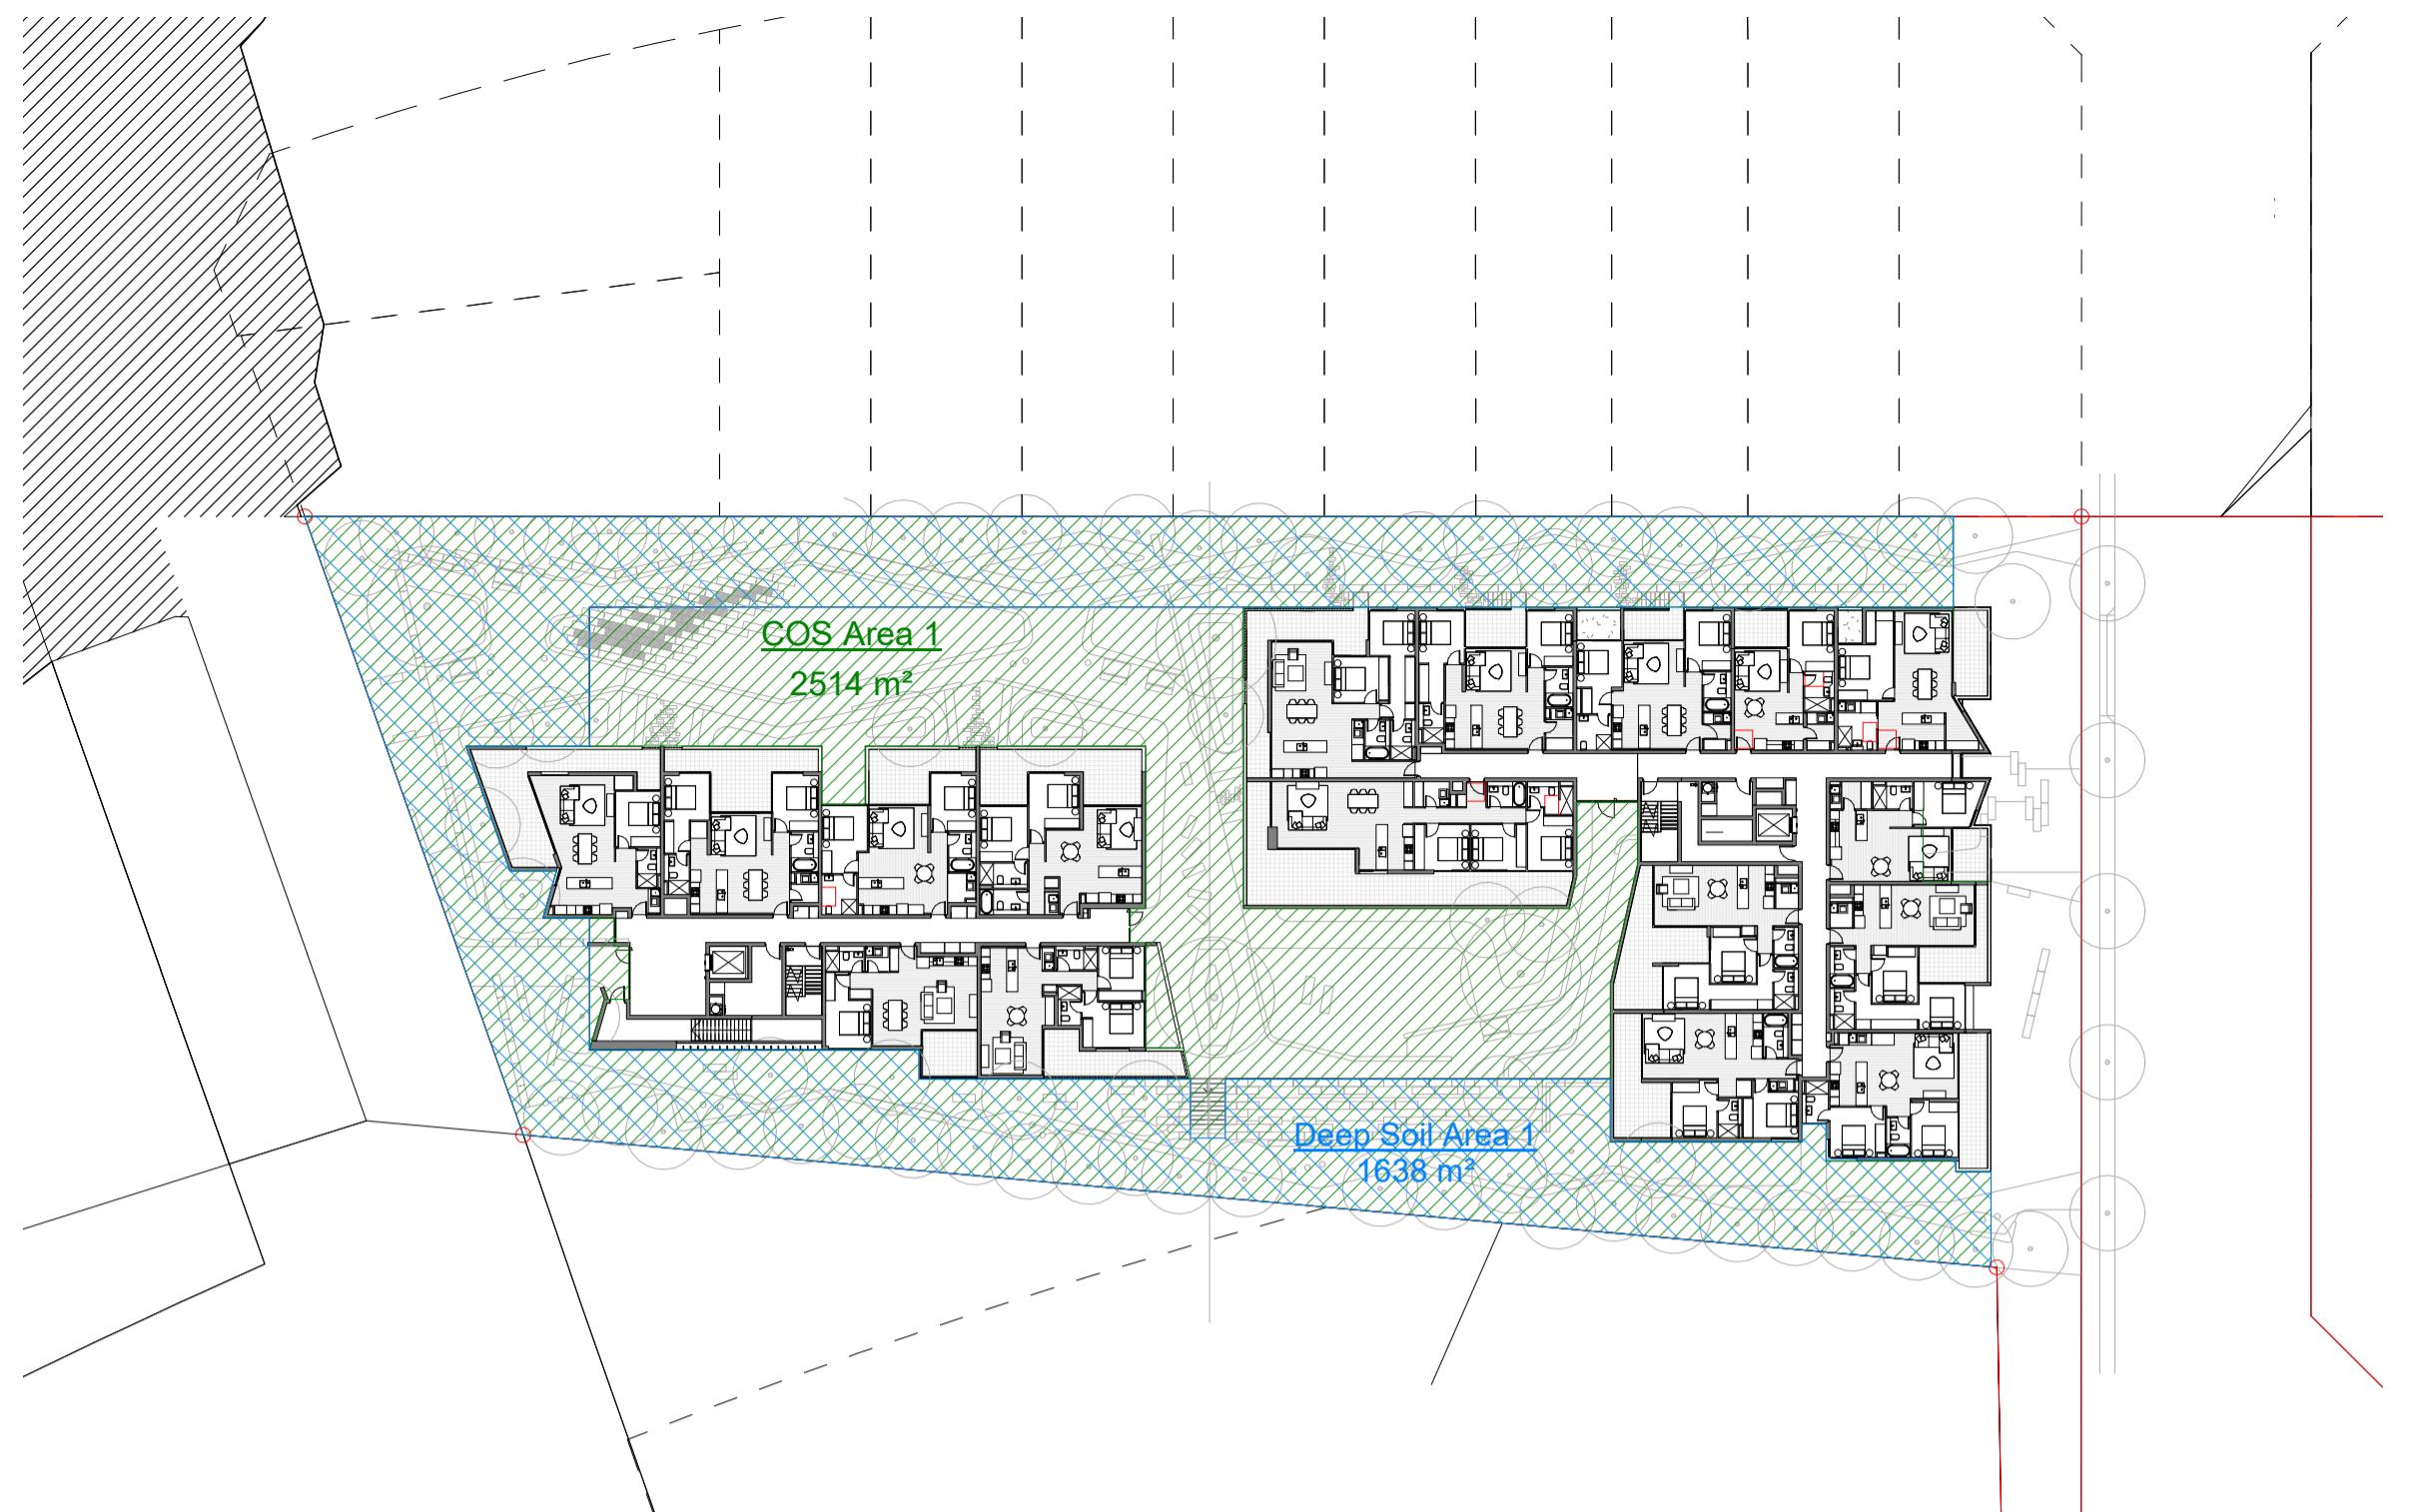03-Nov-21 4:26:23 PM

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NSW ARB Frank Stanisic 4480

project
RESIDENTIAL APARTMENT DEVELOPMENT
LOT 3 DP1259121 SOMME AVENUE + LOT 8 DP1200987 CROATIA AVENUE
EDMONDSON PARK

OPEN SPACE DIAGRAMS

checked drawing
FS
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drawn JN issue
scale bar 0 5 10 15 20 25 m
project no 20 117 drawing no
DA 8016

Attachment C

Previous Results

Table 1 – EI (2018) Composite Soil Samples for Lot 3 DP 1259121 & Lot 8 DP 1200987, Edmondson Park NSW

Sample ID		Material	Sampling Date	Heavy Metals								p,p'-DDE	Total OCPs	Total OPPs				
				As	Cd	Cr [#]	Cu	Pb	Hg	Ni	Zn							
C1	TP101_0.3-0.4	Fill	19/01/2018	7	<0.3	12	10	17	<0.05	3.4	14	<0.1	<1	<1.7				
	TP106_0.1-0.2		19/01/2018															
	TP107_0.1-0.2		19/01/2018															
C2	TP103_0.1-0.2	Fill	19/01/2018	12	<0.3	23	26	37	<0.05	7.7	43	<0.1	<1	<1.7				
	TP104_0.1-0.2		19/01/2018															
	TP105_0.1-0.2		19/01/2018															
C3	TP108_0.1-0.2	Fill	19/01/2018	7	<0.3	14	12	17	<0.05	3.2	13	<0.1	<1	<1.7				
	TP109_0.1-0.2		19/01/2018															
	TP110_0.1-0.2		19/01/2018															
C6	TP119_0.05-0.15	Fill	19/01/2018	12	<0.3	15	25	26	<0.05	7.1	95	<0.1	<1	<1.7				
	TP121_0.1-0.2		19/01/2018															
	TP123_0.1-0.2		19/01/2018															
C7	TP124_0.05-0.15	Fill	19/01/2018	10	<0.3	12	21	22	<0.05	6.1	94	<0.1	<1	<1.7				
	TP126_0.05-0.15		19/01/2018															
	TP127_0.05-0.15		19/01/2018															
C8	TP128_0.05-0.15	Fill	19/01/2018	10	<0.3	16	18	19	<0.05	4.4	24	<0.1	<1	<1.7				
	TP129_0.05-0.15		19/01/2018															
	TP130_0.05-0.15		19/01/2018															
Adopted Soil Criteria																		
HIL B - Residential with minimal soil access				166.7	50	166.7 Cr(VI)	10000	400	40	400	20000	NR	NR	NR				
HIL C - Public Open Space				100	30	100 Cr(VI)	5666.7	200	26.7	400	10000							
HSL D - Commercial / Industrial				Source depths (0 m to <1 m BGL)														
Soil texture classification – Clay ¹				Source depths (1 m to <2 m BGL)														
HSL C - Recreational / Open Space				Source depths (0 m to <1 m BGL)														
Soil texture classification – Clay ¹				Source depths (1 m to <2 m BGL)														
EILs / ESLs - urban residential and public open space ^{1,2}				33.3	NR	66	26.7	400	NR	11.7	48.3	NR	60	NR				
Asbestos contamination HSL B				NR														
Bonded ACM (%w/w)				NR														
Asbestos contamination HSL C				NR														
Bonded ACM (%w/w)				NR														
Asbestos contamination HSL				NR														
Non Bonded / Friable Asbestos (%w/w)				NR														

Notes: All results are recorded in mg/kg, unless otherwise specified. HILs/HSLs and EILs/ESLs have been divided by the number of discrete samples used in each composite (three).

Highlighted value indicates concentration exceeds EIL / ESL.

HIL B NEPC 2013 'HIL B' - Residential with minimal opportunities for soil access; includes dwellings with fully and permanently paved yard space such as high-rise buildings and apartments.

HIL C NEPC 2013 'HIL C' - Public open space.

HSL Health based screening level.

EIL Ecological based investigation level.

ESL Ecological based screening level.

* ESLs are of low reliability except where indicated by * which indicates that the ESL is of moderate reliability.

Thresholds are for Chromium VI.

NR No current published criterion.

NL 'Not Limiting' If the derived soil vapour limit exceeds the soil concentration at which the pore water phase cannot dissolve any more of the individual chemical, i.e. where the soil vapour is at equilibrium with the pore water, then the soil vapour source cannot exceed a level that would result in the maximum allowable vapour risk for the given scenario, therefore the limit is not limiting.

ND 'Not detected' i.e. all concentrations of the compounds within the analyte group were found to be below the laboratory limits of detection.

- The sample was not analysed.

1 As strata is predominantly clay, fine grained soil values were applied.

2 As no physiochemical properties were analysed the most conservative values were adopted for EILs and ESLs.

